



MINOR SITE PLAN SALT SHACK CAFE

TAX MAP PLATE 21: BLOCK 110, LOTS 15.02, 16.01 AND 17.01
TAX MAP PLATE 22: BLOCK 111, LOTS 1, 1.01 AND 1.02
BOROUGH OF SHIP BOTTOM, OCEAN COUNTY, NEW JERSEY

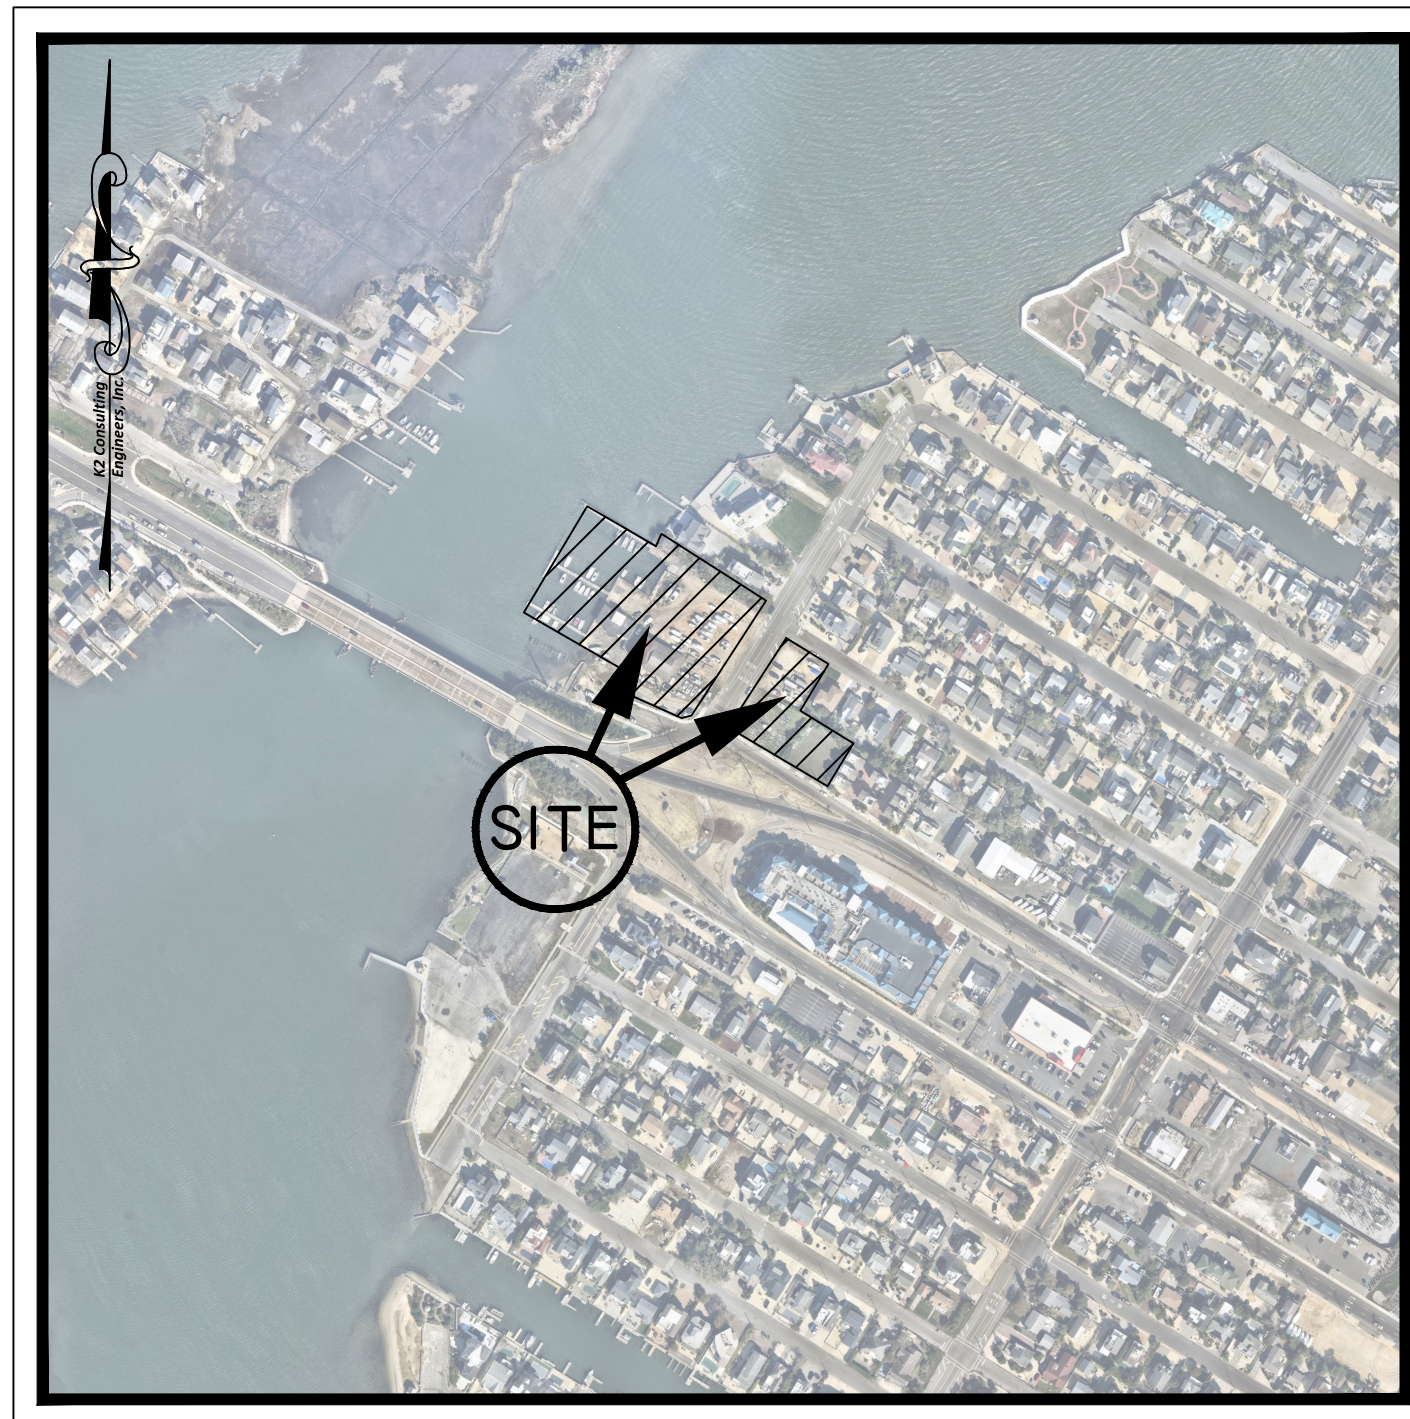


AERIAL MAP

NOT TO SCALE

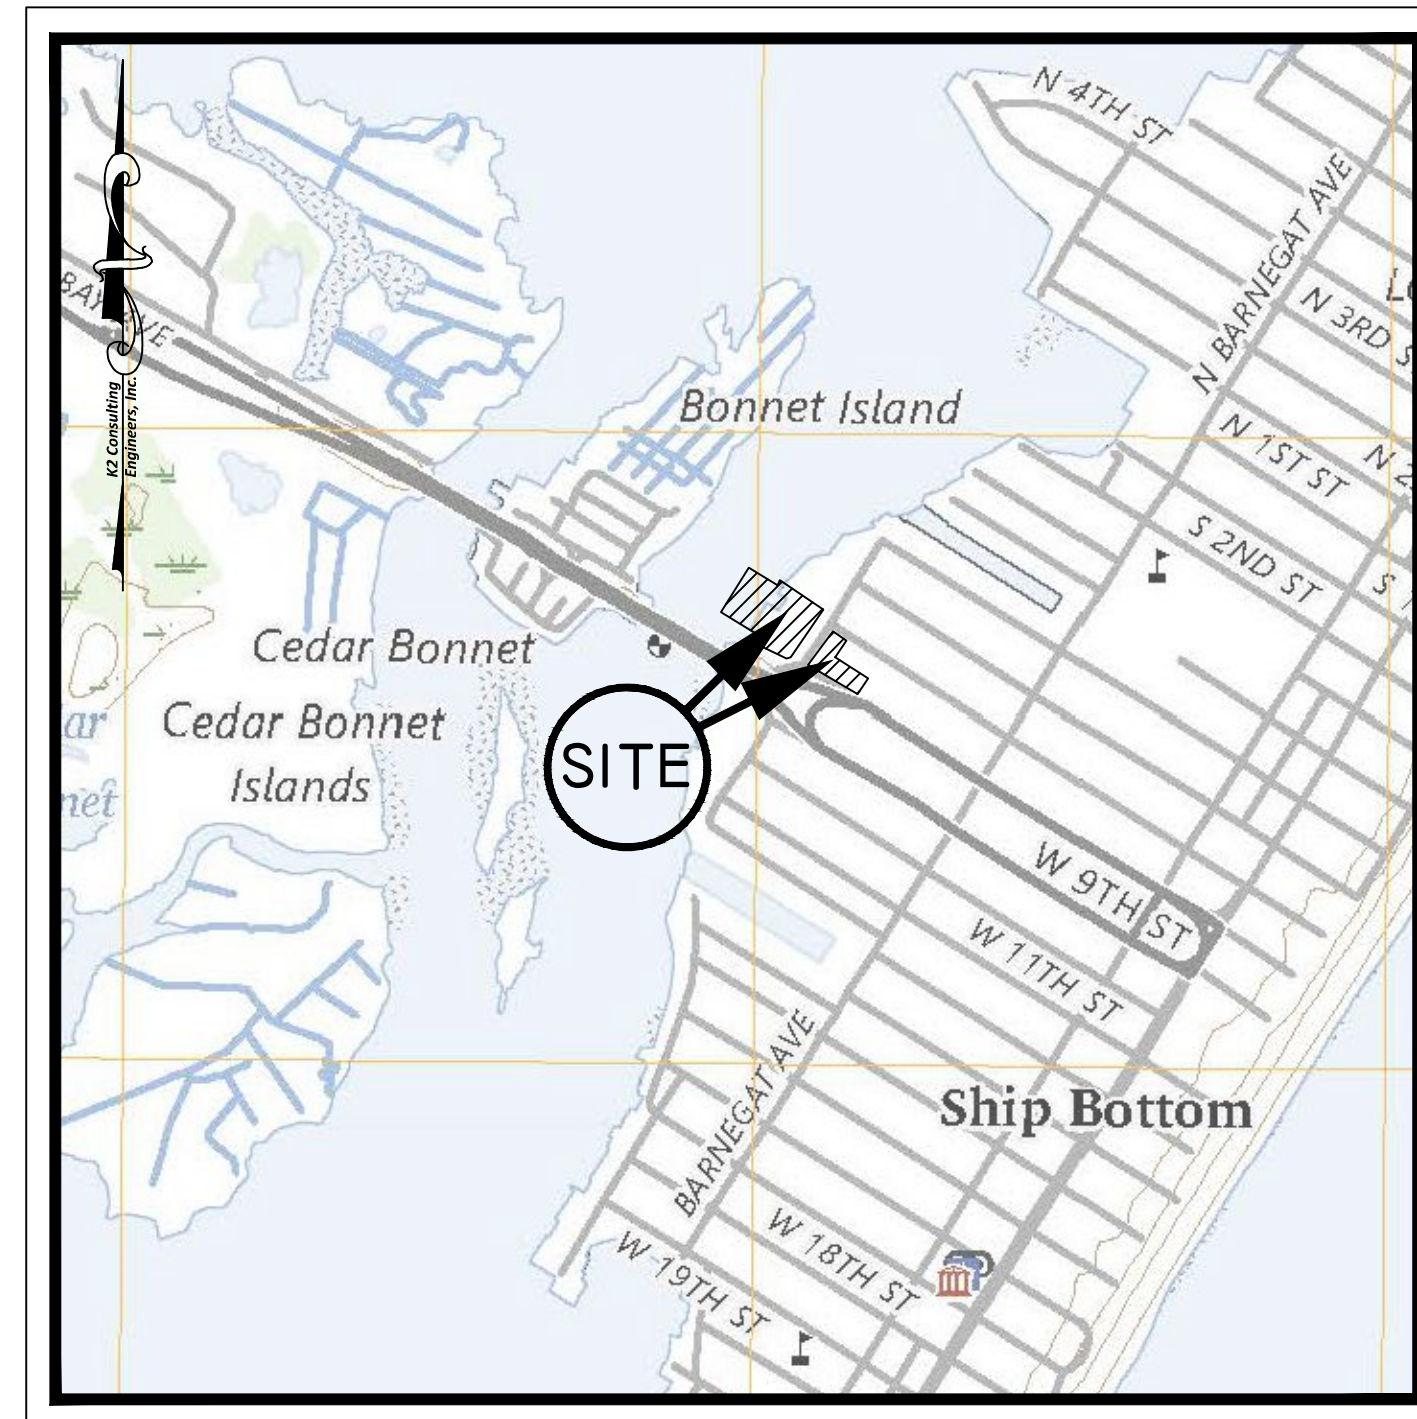


USGS MAP

1" = 1,000'

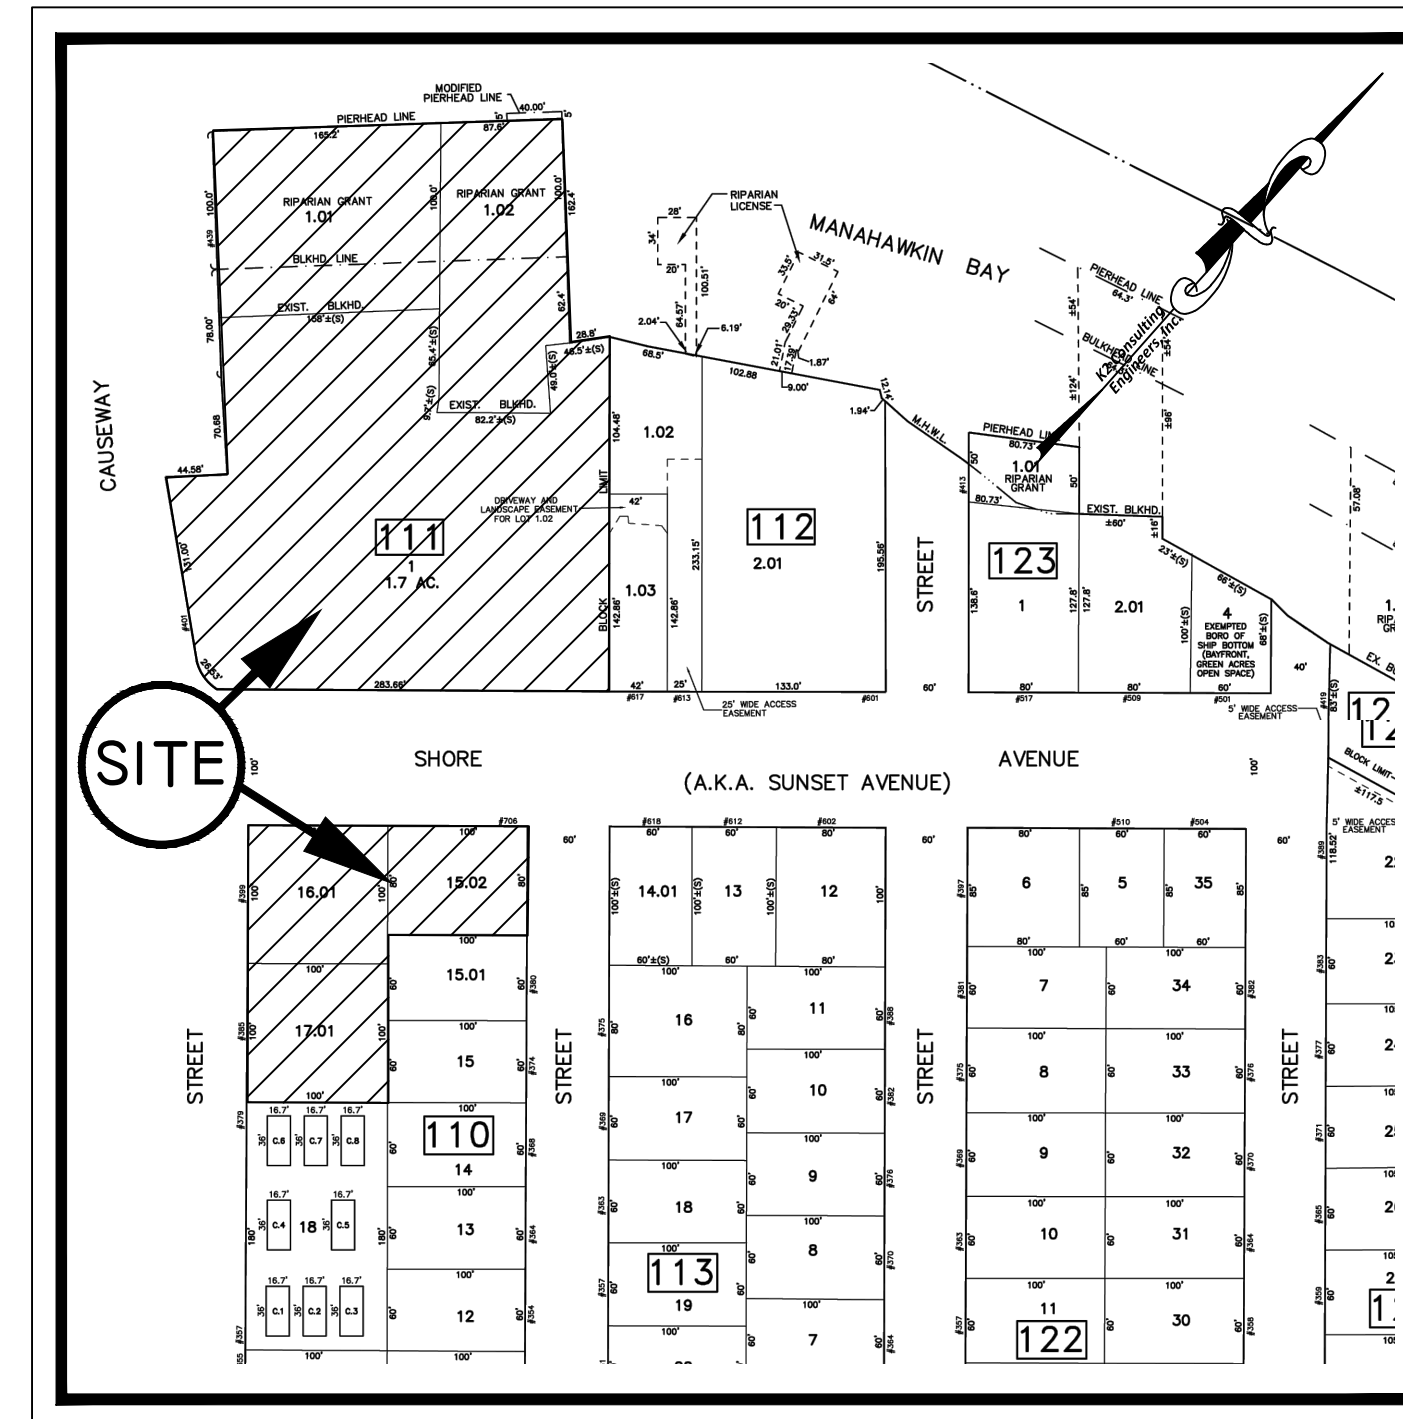

TAX MAP

1" = 200'

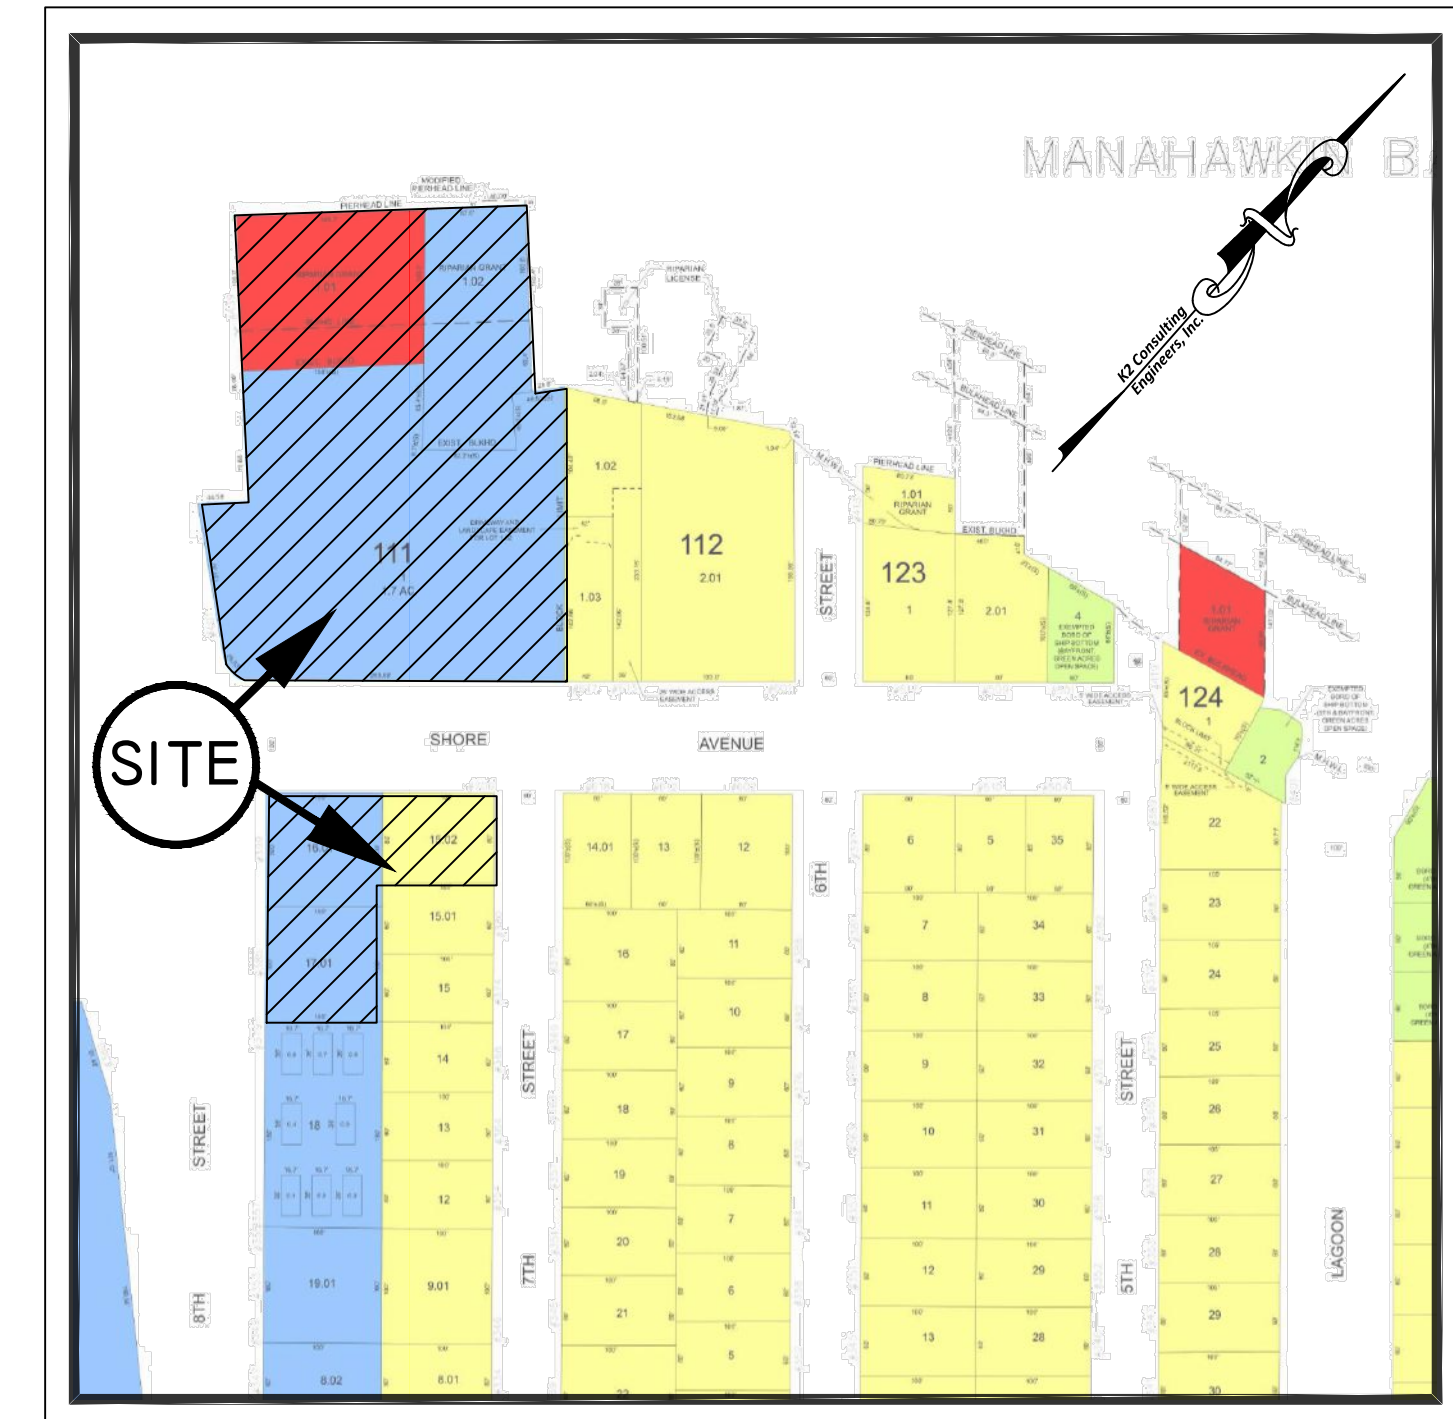

ZONING MAP

1" = 500'

SHEET INDEX		
SHEET NO.	DESCRIPTION	LAST REVISION
CIVIL/SITE DESIGN PLANS		
1 of 5	COVER SHEET	05/05/2026
2 of 5	MINOR SITE PLAN	05/05/2026
3 of 5	MINOR SITE PLAN	05/05/2026
4 of 5	LANDSCAPE AND LIGHTING PLAN	05/05/2026
5 of 5	LANDSCAPE AND LIGHTING PLAN	

NOTE

THIS SET OF PLANS HAS BEEN PREPARED FOR PURPOSES OF MUNICIPAL AND OTHER AGENCY REVIEW AND APPROVAL. THIS SET OF PLANS SHALL NOT BE UTILIZED AS CONSTRUCTION DOCUMENTS UNTIL ALL CONDITIONS OF APPROVALS HAVE BEEN SATISFIED ON THE DRAWINGS AND EACH DRAWING HAS BEEN REVISED TO INDICATE "FINAL ISSUED FOR CONSTRUCTION".

DWG. NAME: W:\PROJECT FILES\PD26 Projects\PD26-021 - Hochstrasser Ship Bottom\09-AUTOCAD\DESIGN\cover.dwg

K2
Consulting Engineers, Inc.

Professional Civil Engineers
Certificate of Authorization
#24GA26187400

36 Tanner Street, Suite 100
Haddonfield, NJ 08033
Phone - 856.310.5205
Fax - 856.616.2441
www.K2CE.com

DATE	REVISION	BY
05/20/2026	REVISED PER BOROUGH REQUEST	WFR
05/05/2026	REVISED PER LANDSCAPING & LIGHTING	WFR
04/09/2026	REVISED PER GENERAL COMMENT	JWK


COVER SHEET
SALT SHACK CAFE
401 W 8TH STREET
BLOCK 110 - LOTS 15.02, 16.01 AND 17.01 - TAX MAP SHEET 21
BLOCK 111 - LOTS 1, 1.01 AND 1.02 - TAX MAP SHEET 22
BOROUGH OF SHIP BOTTOM, OCEAN COUNTY, NEW JERSEY

JOHN W. KORNICK, P.E.
Professional Engineer, New Jersey Lic. No. 24GE04928500

DATE: 03/26/2026	DESIGN BY: JWK
DRAWN BY: TLM	SCALE: AS SHOWN
JOB NO.: PD26-021	SHEET 1 OF 5

DWG. NAME: W:\PROJECT FILES\PD26\Projects\PD26-021 - Hochstrasser Ship Bottom\09-AUTOCAD\DESIGN\Layout.dwg

MANAHAWKIN BAY

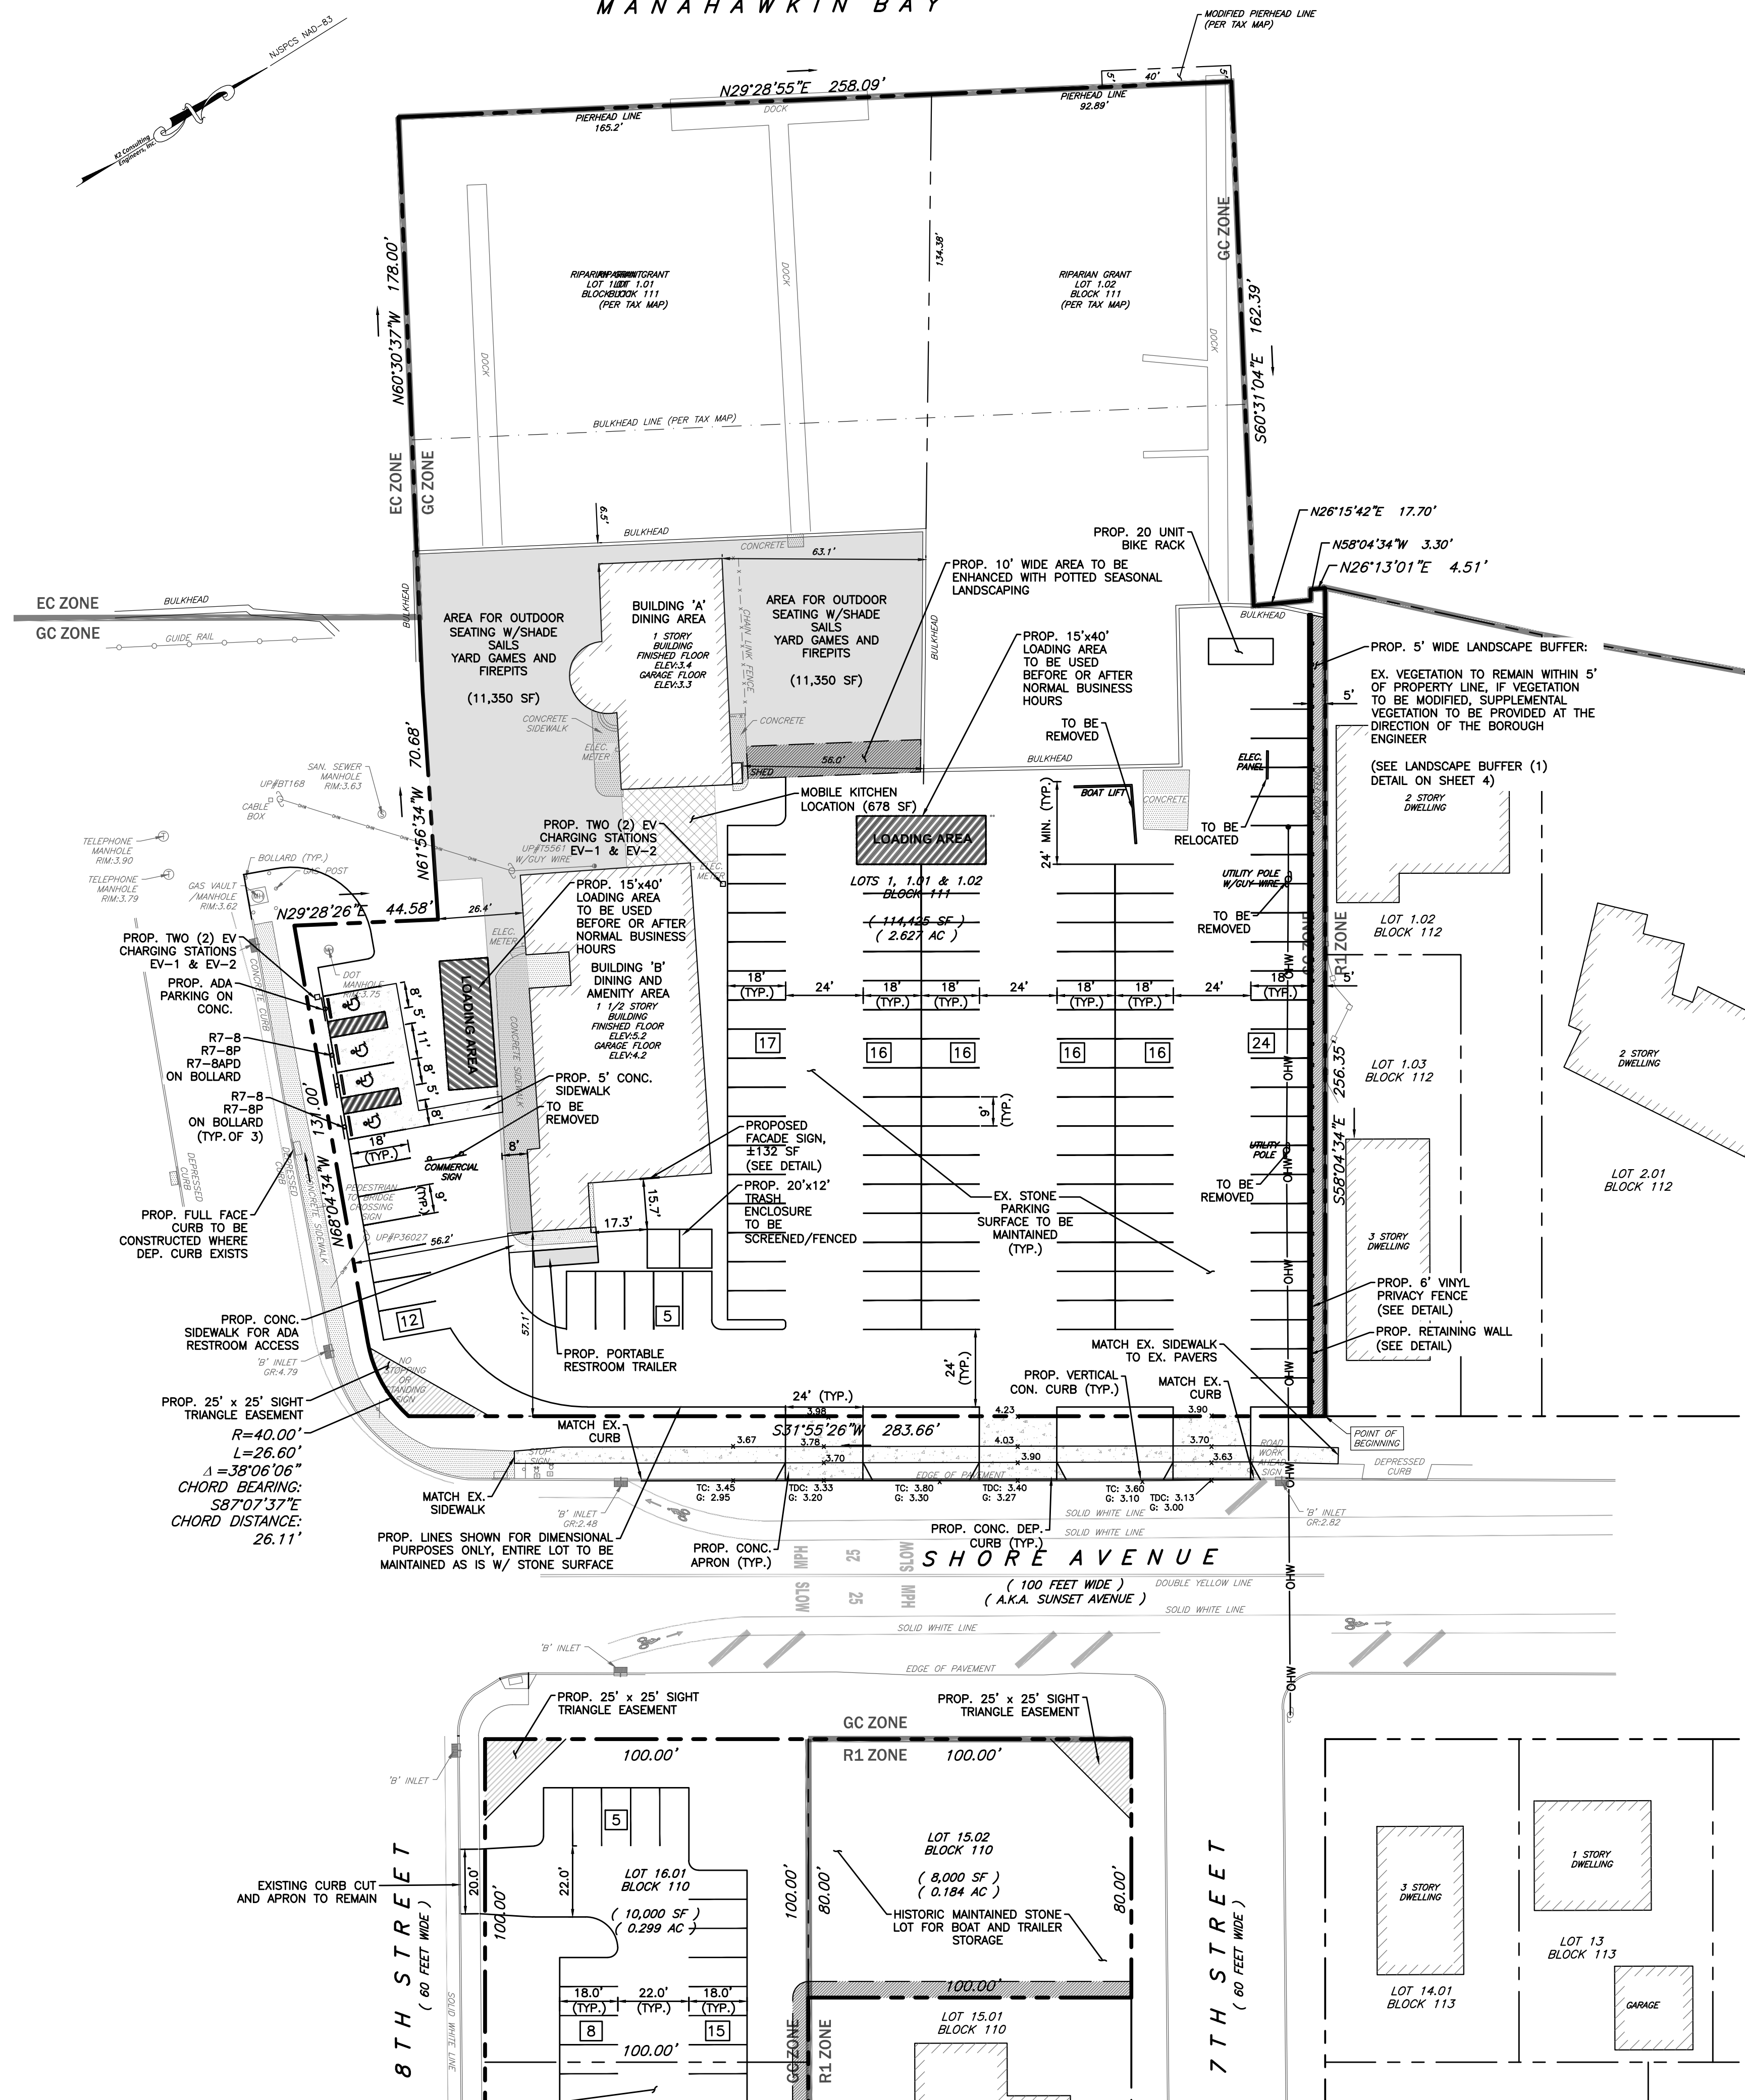

ZONING REQUIREMENTS

ZONING DISTRICT: GC - GENERAL COMMERCIAL DISTRICT (RELATED USES CRITERIA)
BOROUGH OF SHIP BOTTOM, OCEAN COUNTY, NEW JERSEY
TAX MAP 22 - BLOCK 111 - LOTS 1, 1.01 AND 1.02 (LOTS 1.01 AND 1.02 ARE WATERWARD OF EX. BULKHEAD)
BULK REQUIREMENTS TAKEN FROM LOTS LINES OF LOT 1

Table with 5 columns: CATEGORY, REQUIRED, EXISTING, PROPOSED, NOTES. Lists requirements for minimum lot area, frontage, width, yard, height, coverage, etc.

(C) CONFORMS
(V) VARIANCE
(E) EXISTING NON-CONFORMING CONDITION

* DIMENSION TAKEN FROM EX. BUILDING 'A' TO THE BULKHEAD FACE WHICH IS THE COMMON LOT LINE BETWEEN LOT 1 AND LOT 1.01 OR LOT 1.02.

PARKING REQUIREMENTS

ZONING DISTRICT: GC - GENERAL COMMERCIAL DISTRICT (RELATED USES CRITERIA)
OFF-STREET PARKING PER SECTION 16.48.010.F & 16.52.080
BOROUGH OF SHIP BOTTOM, OCEAN COUNTY, NEW JERSEY
TAX MAP 21 - BLOCK 110 - LOTS 15.01, 16.01 AND 17.01
TAX MAP 22 - BLOCK 111 - LOTS 1, 1.01 AND 1.02

Table with 3 columns: CATEGORY, REQUIRED, PROPOSED, NOTES. Lists requirements for restaurants, marinas, and buffer planting strips.

NOTE: EMPLOYEE PARKING TO BE PROVIDED ON BLOCK 110, LOTS 16.01 AND 17.01.

(C) CONFORMS
(V) VARIANCE


SIGNAGE REQUIREMENTS

ZONING DISTRICT: GC - GENERAL COMMERCIAL DISTRICT (RELATED USES CRITERIA)
SIGNAGE PER SECTION 16.52.130 & 16.48.010.H
BOROUGH OF SHIP BOTTOM, OCEAN COUNTY, NEW JERSEY
TAX MAP 22 - BLOCK 111 - LOT 1

Table with 4 columns: CATEGORY, REQUIRED, PROPOSED, NOTES. Lists requirements for facade sign area and mounted signs.

GENERAL NOTES:

- 1. OWNER: LOUIS HOCHSTRASSER
336 FOURTH STREET
SURF CITY, NJ 08008
APPLICANT: BALDWIN GRILL LLC
4569 SOUTH BROAD STREET, ST 200
HAMILTON, NJ 08620
2. TRACT IS KNOWN AS BLOCK 111 LOT 1 AND BLOCK 110 LOT 15.02 AS SHOWN ON PLATE 22 AND 21 OF THE OFFICIAL TAX MAP OF THE BOROUGH OF SHIP BOTTOM, OCEAN COUNTY, NEW JERSEY.
3. TOTAL TRACT AREA: BLOCK 111, LOT 1: 116,503 SF (2.674 ACRES) MORE OR LESS.
BLOCK 110, LOT 15.02: 8,000 SF (0.2 ACRES) MORE OR LESS
4. THE SUBJECT TRACT IS ZONED IN THE GC GENERAL COMMERCIAL ZONING DISTRICT (BLOCK 111, LOT 1) AND R1 RESIDENTIAL ZONING DISTRICT (BLOCK 110, LOT 15.02) AS INDICATED ON THE ZONE MAP DATED AUGUST 2018 AS PROVIDED BY THE BOROUGH OF SHIP BOTTOM.
5. PRESENT USE: MARINA WITH ACCESSORY USES, EXISTING BOAT STORAGE (SEASONAL) AND ON-LOT PARKING
PROPOSED USE: MARINA WITH ACCESSORY USES, EXISTING BOAT STORAGE (SEASONAL) AND ON-LOT PARKING
6. BOUNDARY & EXISTING CONDITION INFORMATION HAS BEEN BASED UPON A FIELD SURVEY AND PLAN ENTITLED 'PLAN OF SURVEY AND TOPOGRAPHY' AS PREPARED BY JOHN J. PANKOK P.L.S. OF K2 CONSULTING ENGINEERS, INC., DATED MARCH 9, 2026.
7. LOT LINES AND ADJOINING LOT LINES SHOWN HEREON ARE TAKEN FROM THE OFFICIAL TAX MAPS OF THE BOROUGH OF SHIP BOTTOM.
8. THIS SITE PLAN WAIVER APPLICATION IS FOR THE CONTINUATION OF THE MARINA AND FOOD SERVICES OPERATIONS, UPGRADING THE SITE, IDENTIFYING PARKING AND BOAT STORAGE AS HISTORICALLY USED. EMPLOYEE PARKING TO BE PROVIDED ON BLOCK 110, LOTS 16.01 AND 17.01.
9. NO PHASING IS PROPOSED FOR THIS DEVELOPMENT.
10. PROPERTY IS LOCATED WITHIN ZONE AE9 (ELEV. 9) THE 100 YEAR FLOOD ZONE AS PER 2009 FEMA FLOOD INSURANCE RATE MAP 34029C0603F, EFFECTIVE DATE SEPTEMBER 29, 2006.
11. PROPERTY DOES NOT CONTAIN, NOR IS IT ADJACENT TO, FRESHWATER WETLANDS AS PER THE NIDEP GIS DATABASE FOR CAMDEN COUNTY.
12. THE PROJECT IS LOCATED WITHIN STATE PLANNING AREA PAS-ENVIRONMENTALLY SENSITIVE. PROPERTY ABOVE THE MEAN HIGH WATER IS LOCATED IN A CAFRA CENTER - COASTAL TOWN.
13. THE PROJECT IS LOCATED WITHIN THE BARNEGAT BAY WATERSHED, SUB-WATERSHED - 13KA09 MANAHAWKIN/LEH BAY (MILLCRK-TURTLECOVE) HUC14 #02040301130090.
14. RELOCATED GAS MAINS, TELEPHONE LINES, CABLE TELEVISION LINES AND ELECTRICITY LINES MUST BE INSTALLED UNDERGROUND, IF REQUIRED. ACTUAL LOCATIONS OF THESE UTILITY SERVICES SHALL BE COORDINATED WITH THE RESPECTIVE UTILITY COMPANIES.
15. THE CONTRACTOR SHALL BE RESPONSIBLE FOR FIELD VERIFYING THE LOCATION AND DEPTH OF ALL EXISTING UTILITIES IN AREAS OF PROPOSED CONSTRUCTION. ANY DISCREPANCIES FOUND IN THE FIELD SHALL BE BROUGHT TO THE ATTENTION OF THE ENGINEER.
16. SITE IS CURRENTLY SERVICED BY PUBLIC WATER AND PUBLIC SEWER.
17. THE CONTRACTORS ARE REQUIRED TO CALL FOR A MARKOUT NOT LESS THAN THREE BUSINESS DAYS OR MORE THAN TEN BUSINESS IN ADVANCE OF COMMENCING ANY EXCAVATION WORK.
18. ALL ACCESSIBLE FACILITIES SHALL BE DESIGNED AND CONSTRUCTED IN CONFORMANCE, WITH THE REQUIREMENTS OF THE NJ BARRIER-FREE SUBCODE 5.23-7 AND CURRENT A.D.A. REQUIREMENTS.
19. THE OWNER OR HIS REPRESENTATIVE, IS TO DESIGNATE AN INDIVIDUAL RESPONSIBLE FOR CONSTRUCTION SITE SAFETY DURING THE COURSE OF SITE IMPROVEMENTS PURSUANT TO N.J.A.C. 5:23-2.21(e) OF THE NEW JERSEY CONSTRUCTION CODE AND CFR 1926.32(f) (OSHA COMPETENT PERSON).
20. LOTS SHALL BE CONSOLIDATED BY DEED.
21. THE PROPOSED APPLICATION WILL REQUIRE APPROVALS FROM THE FOLLOWING AGENCIES:
- BOROUGH OF SHIP BOTTOM PLANNING BOARD
- OCEAN COUNTY PLANNING BOARD
22. HOURS OF OPERATION
SUNDAY - THURSDAY: 12 PM - 10 PM
FRIDAY - SATURDAY: 12 PM - 10 PM
23. INDOOR SEATING COUNT:
BUILDING A: 93 SEATS
BUILDING B: 96 SEATS
TOTAL INDOOR SEATING = 189 SEATS
TOTAL OUTDOOR SEATING = 171 SEATS
24. MOBILE/PORTABLE RESTROOMS ARE TO BE REMOVED FROM THE SITE UPON COMPLETION OF THE INTERNAL BUILDING BATHROOM FIT-OUT.
25. THE BOROUGH OF SHIP BOTTOM NOISE ORDINANCE, CHAPTER 8.16 SHALL BE ADHERED TO. NOISE STUDY TO BE PROVIDED WITHIN 60-DAYS OF OPERATING.

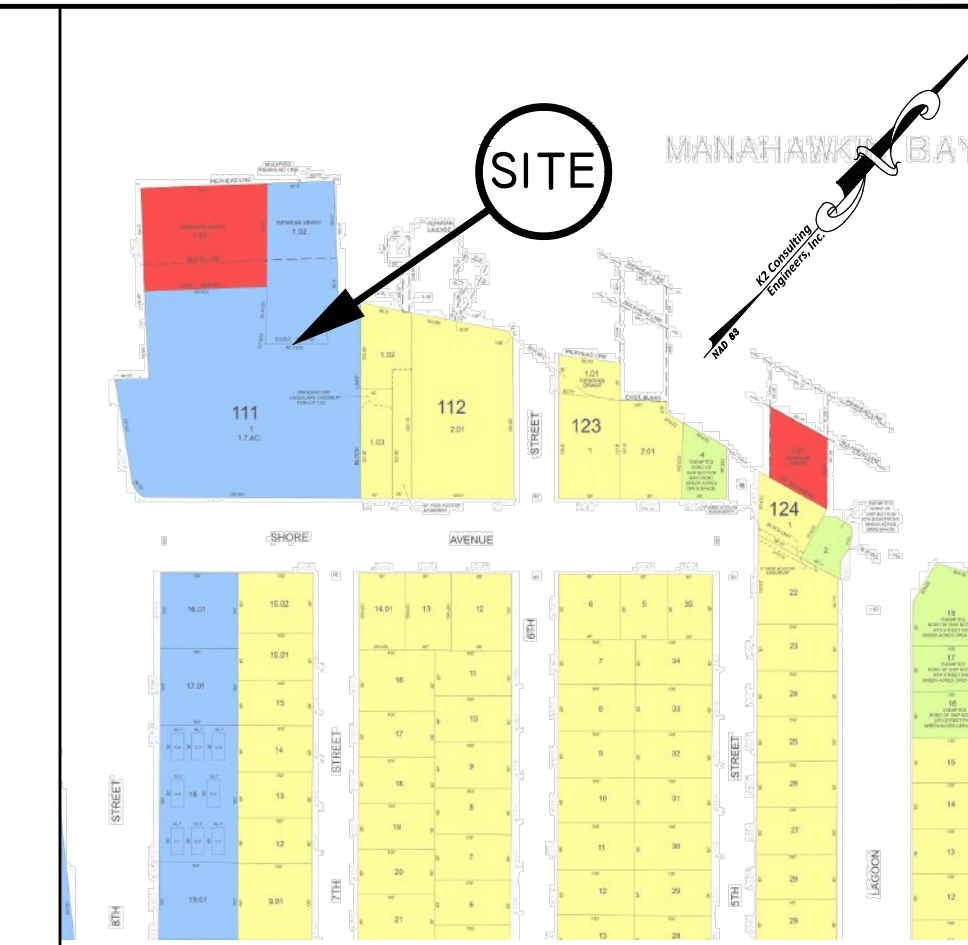

ZONING MAP NOT TO SCALE

ELECTRIC VEHICLE PARKING SCHEDULE
PROPOSED USE: MIXED USE COMMERCIAL / MARINA
CATEGORY: REQUIRED
TOTAL MAKE READY SPACES REQUIRED (PARKING LOT 101-150 SPACES) = 4


K2 Consulting Engineers, Inc.
Professional Civil Engineers
Certificate of Authorization #24GA26187400
36 Tanner Street, Suite 100
Haddonfield, NJ 08033
Phone: 856.310.5025
Fax: 856.616.2441
www.K2CE.com


Revision table with columns: DATE, REVISION, BY. Includes entries for 'REVISED PER BOROUGH REQUEST', 'REVISED PER LANDSCAPING & LIGHTING', and 'REVISED PER GENERAL COMMENT'.

MINOR SITE PLAN
401 W 8TH STREET
BLOCK 111 - LOTS 1, 1.01 AND 1.02 - TAX MAP SHEET 22
BLOCK 110 - LOT 15.01, 16.01 AND 17.01 - TAX MAP SHEET 21
BOROUGH OF SHIP BOTTOM, OCEAN COUNTY, NEW JERSEY

JOHN W. KORNICK, P.E.
Professional Engineer, New Jersey Lic. No. 24GE04928500

DATE: 03/26/2026
DESIGN BY: JWK
DRAWN BY: TLM
SCALE: 1"=30'
JOB NO.: PD26-021
SHEET: 2 OF 5

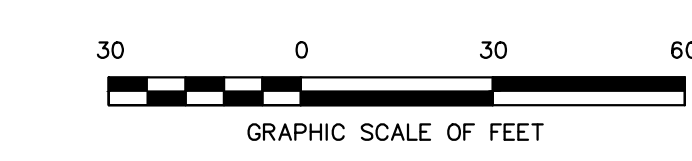

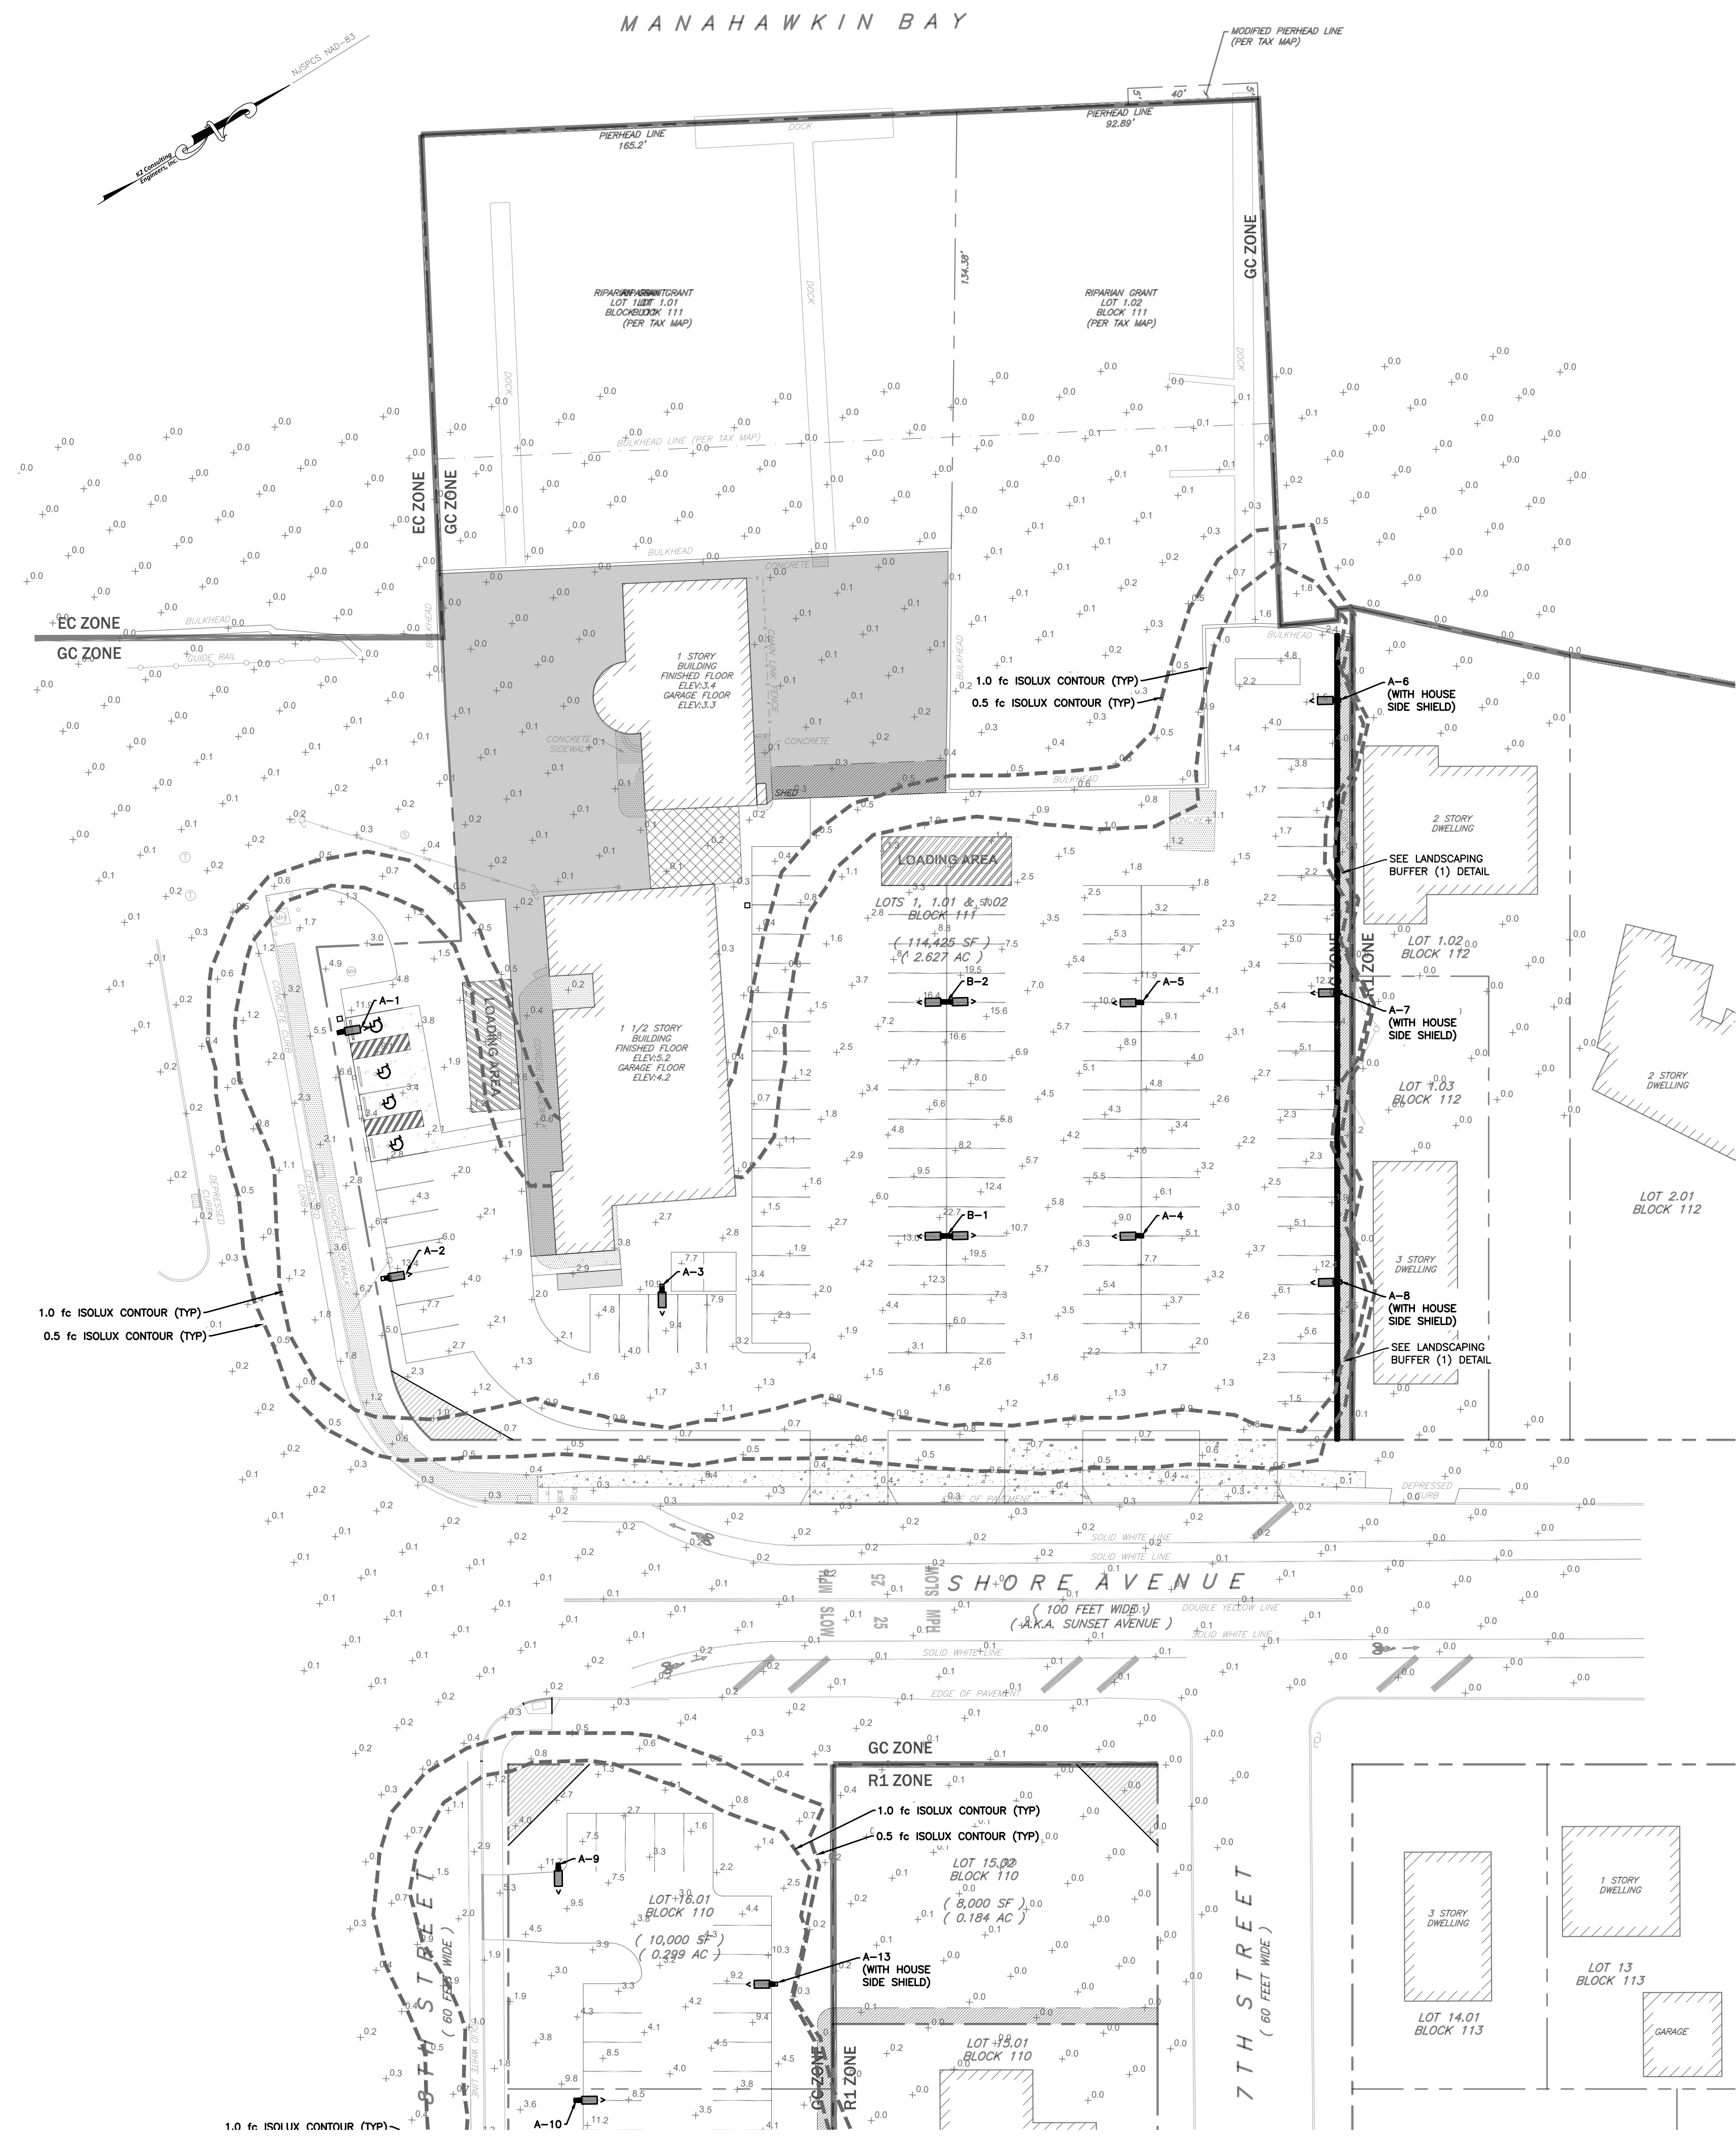

LANDSCAPE SCHEDULE





KEY	BOTANICAL NAME	COMMON NAME	QTY.	SIZE	TYPE
PA	PICEA ABIES	Norway Spruce	SEE NOTE #1	5'-6'	Evergreen Tree, B & B
PP	PICEA PUNGENS	Blue Colorado Spruce	SEE NOTE #1	5'-6'	Evergreen Tree, B & B
JPT	JUNIPERUS CHINENSIS 'TORULOSA'	Hollywood Juniper	SEE NOTE #1	24"	Evergreen Shrub, Cont.
BXV	BUXUS SEMPERVIRENS	Variegated Leaf Boxwood	SEE NOTE #1	24"	Evergreen Shrub, Cont.

LIGHTING SCHEDULE

SYMBOL	QTY	LABEL	LUMENS	LAMPS	WATTS	DESCRIPTION
□	13	A-#	ABSOLUTE	1	150	RAB LIGHTING A17-A150 DIE-CAST ALUMINUM HOUSING, TYPE IV POLE MOUNTED (20' HEIGHT)
◀◻◻▶	2	B-#	ABSOLUTE	1	150	RAB LIGHTING A17-A150 (DOUBLE FIXTURE) DIE-CAST ALUMINUM HOUSING, TYPE IV POLE MOUNTED (20' HEIGHT)

LANDSCAPING & LIGHTING NOTES:


- EXISTING PLANTINGS IN LOCATION OF PROPOSED LANDSCAPING BUFFER TO REMAIN, AND BE SUPPLEMENTED WHERE NECESSARY, UTILIZING THE PLANTINGS SHOWN IN THE LANDSCAPING SCHEDULE ABOVE. LOCATIONS OF REQUIRED SUPPLEMENTAL PLANTINGS TO BE DETERMINED AT TIME OF CONSTRUCTION. PLANTINGS TO FOLLOW THE DETAIL AS SHOWN BELOW.
- ALL EXPOSED AREAS NOT OCCUPIED WITH IMPROVEMENTS, STONE OR MULCH SHALL BE SEEDED AND MULCHED PER THE STANDARDS FOR SOIL EROSION AND SEDIMENT CONTROL IN NEW JERSEY.
- SUPPLEMENT EXISTING PLANTING AREAS AS NEEDED TO MAINTAIN PROPER PLANT HEALTH, AESTHETICS, AND BUFFERING TO ADJACENT RESIDENTIAL USES.
- SEE LIGHTING DETAILS AND ADDITIONAL LANDSCAPING DETAILS ON SHEET 5.

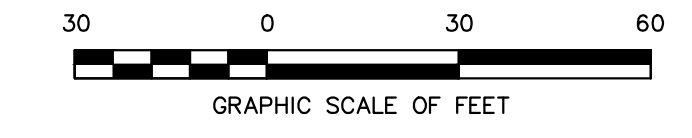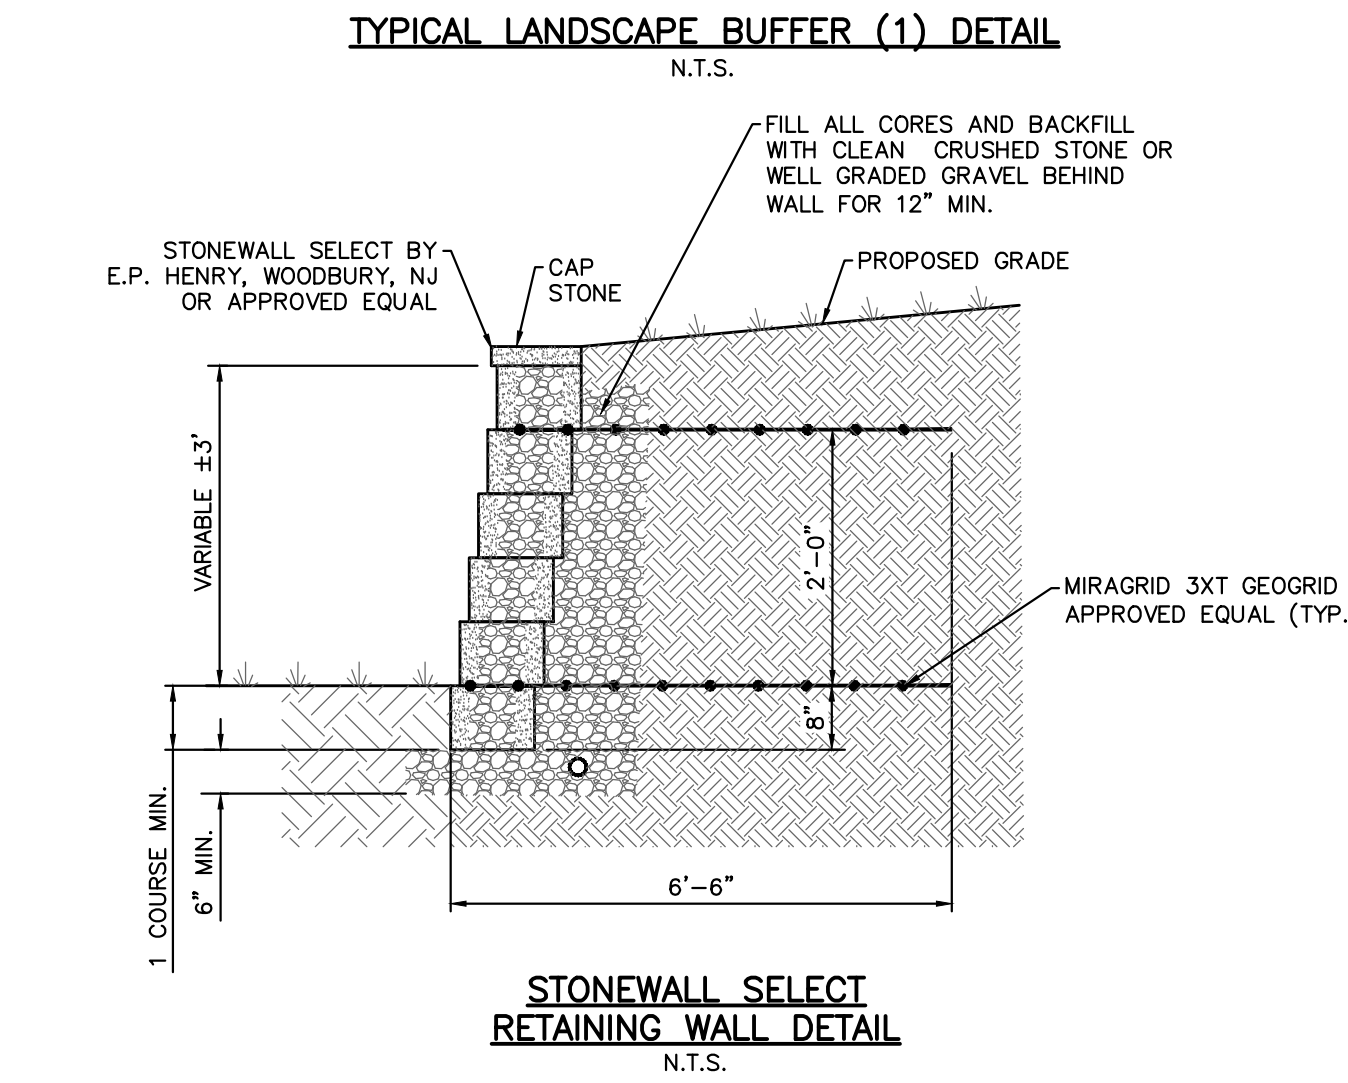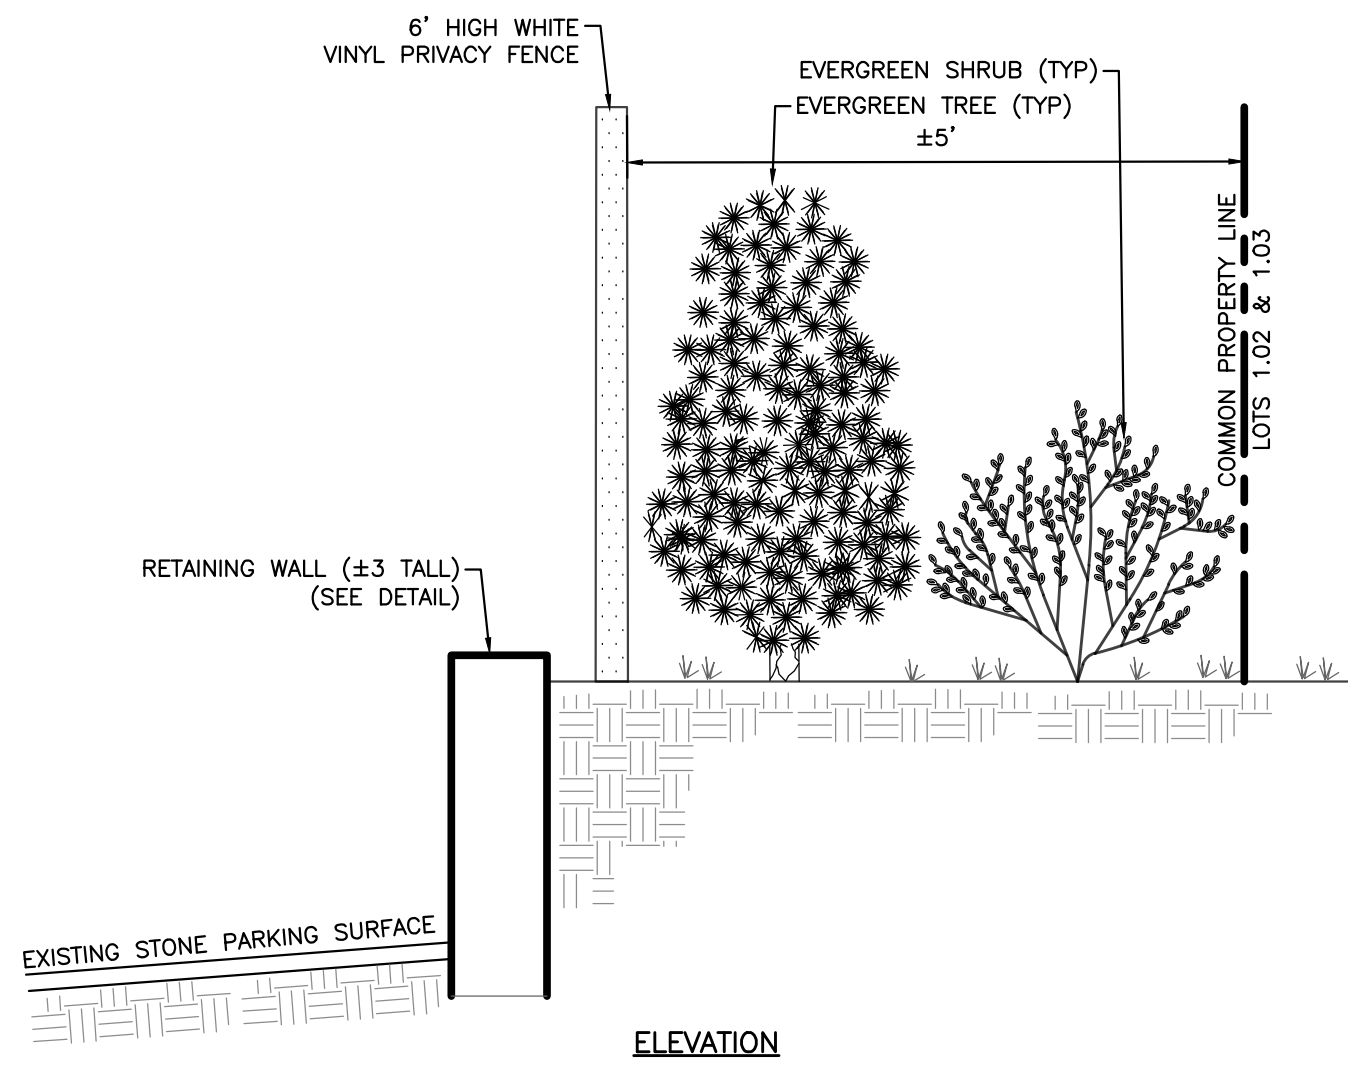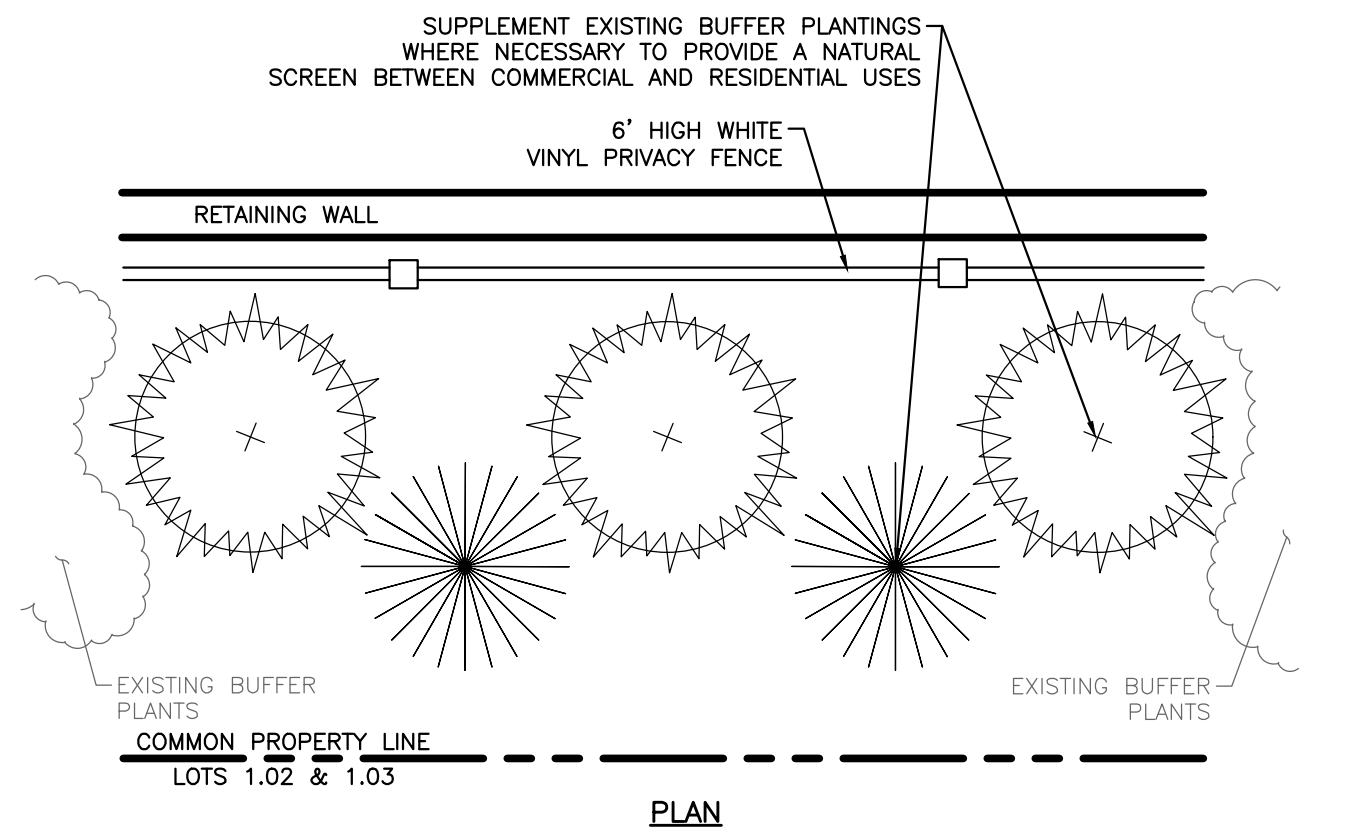

DATE	REVISION	BY
05/20/2026 <td>REVISED PER BOROUGH REQUEST <td>WFR</td> </td>	REVISED PER BOROUGH REQUEST <td>WFR</td>	WFR

LANDSCAPE & LIGHTING PLAN
401 W 8TH STREET
BLOCK 111 - LOTS 1, 1.01 AND 1.02 - TAX MAP SHEET 22
BLOCK 110 - LOT 15.01, 16.01 AND 17.01 - TAX MAP SHEET 21
BOROUGH OF SHIP BOTTOM, OCEAN COUNTY, NEW JERSEY

JOHN W. KORNICK, P.E.
Professional Engineer, New Jersey Lic. No. 24GE04928500

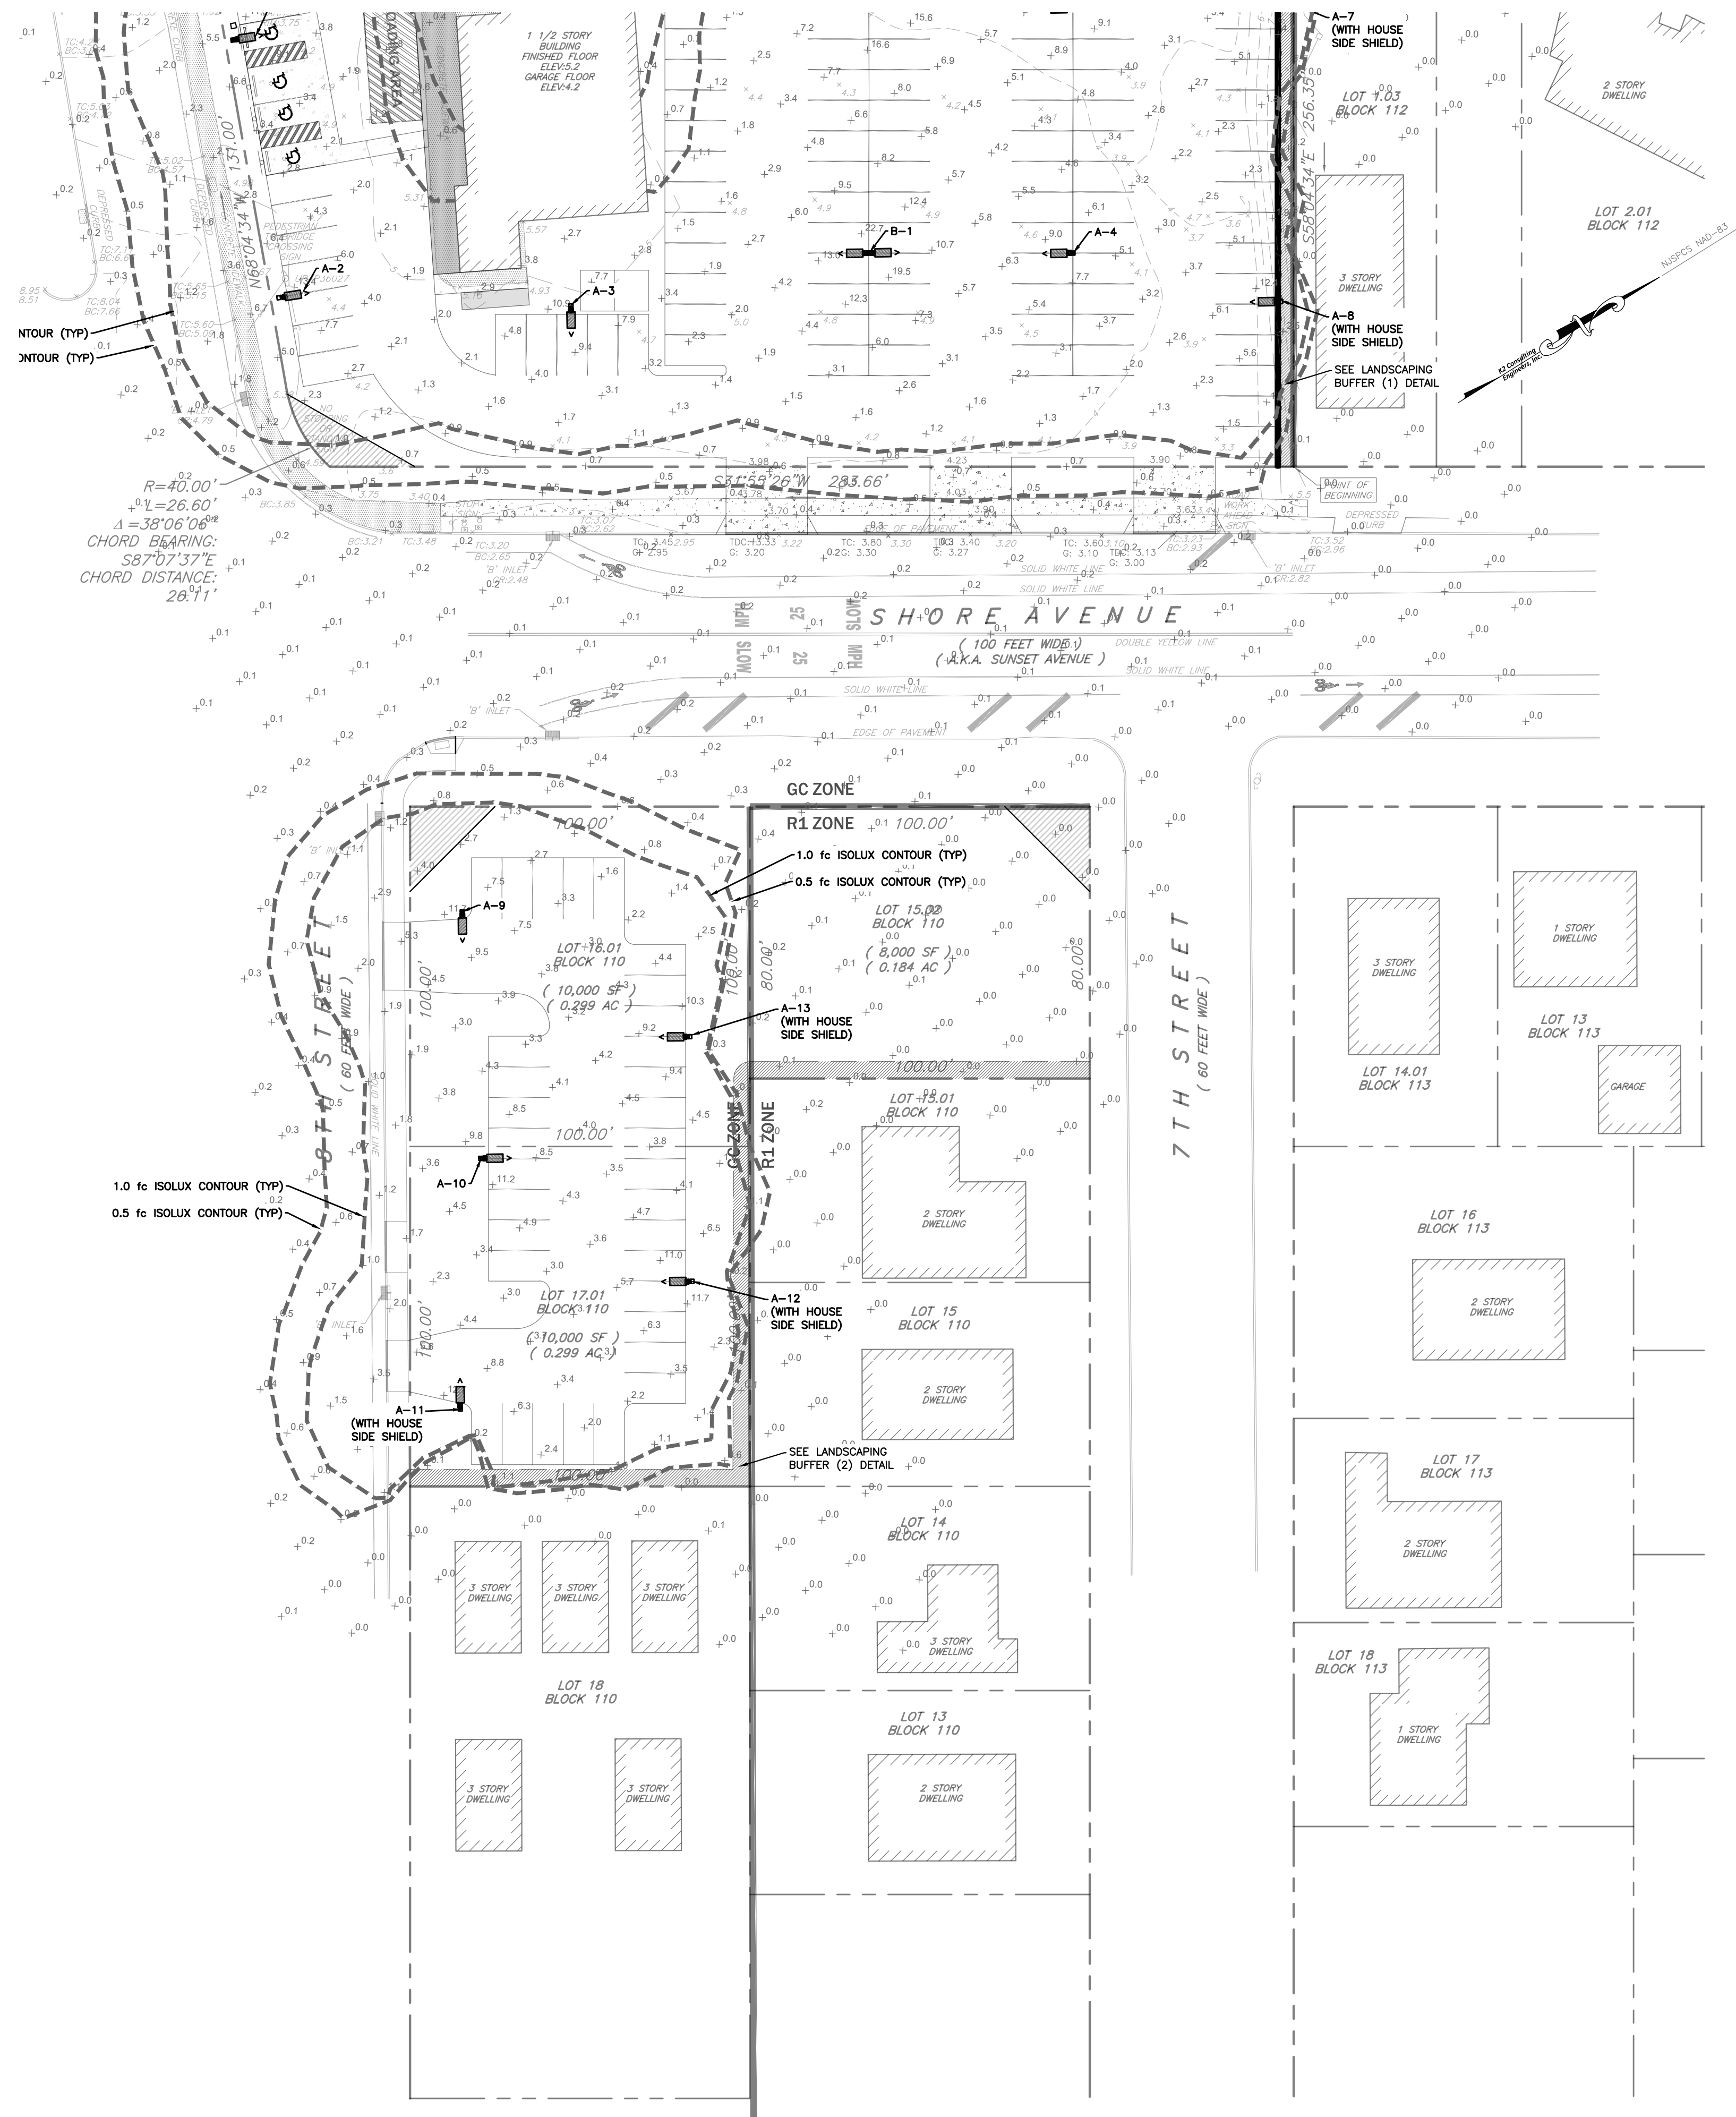

LANDSCAPE SCHEDULE


KEY	BOTANICAL NAME	COMMON NAME	QTY.	SIZE	TYPE
PA	PICEA ABIES	Norway Spruce	SEE NOTE #1	5'-6"	Evergreen Tree, B & B
PP	PICEA PUNGENS	Blue Colorado Spruce	SEE NOTE #1	5'-6"	Evergreen Tree, B & B
JPT	JUNIPERUS CHINENSIS 'TORULOSA'	Hollywood Juniper	SEE NOTE #1	24"	Evergreen Shrub, Cont.
BXV	BUXUS SEMPERVIRENS	Variegated Leaf Boxwood	SEE NOTE #1	24"	Evergreen Shrub, Cont.

LIGHTING SCHEDULE


SYMBOL	QTY	LABEL	LUMENS	# LUMPS	WATTS	DESCRIPTION
☐➤	13	A-#	ABSOLUTE	1	150	RAB LIGHTING A17-4T150 DIE-CAST ALUMINUM HOUSING, TYPE IV POLE MOUNTED (20' HEIGHT)
☐➤☐➤	2	B-#	ABSOLUTE	1	150	RAB LIGHTING A17-4T150 (DOUBLE FIXTURE) DIE-CAST ALUMINUM HOUSING, TYPE IV POLE MOUNTED (20' HEIGHT)

LANDSCAPING & LIGHTING NOTES:

- EXISTING PLANTINGS IN LOCATION OF PROPOSED LANDSCAPING BUFFER TO REMAIN, AND BE SUPPLEMENTED WHERE NECESSARY, UTILIZING THE PLANTINGS SHOWN IN THE LANDSCAPING SCHEDULE ABOVE. LOCATIONS OF REQUIRED SUPPLEMENTAL PLANTINGS TO BE DETERMINED AT TIME OF CONSTRUCTION. PLANTINGS TO FOLLOW THE DETAIL AS SHOWN BELOW.
- ALL EXPOSED AREAS NOT OCCUPIED WITH IMPROVEMENTS, STONE OR MULCH SHALL BE SEEDED AND MULCHED PER THE STANDARDS FOR SOIL EROSION AND SEDIMENT CONTROL IN NEW JERSEY.
- SUPPLEMENT EXISTING PLANTING AREAS AS NEEDED TO MAINTAIN PROPER PLANT HEALTH, AESTHETICS, AND BUFFERING TO ADJACENT RESIDENTIAL USES.

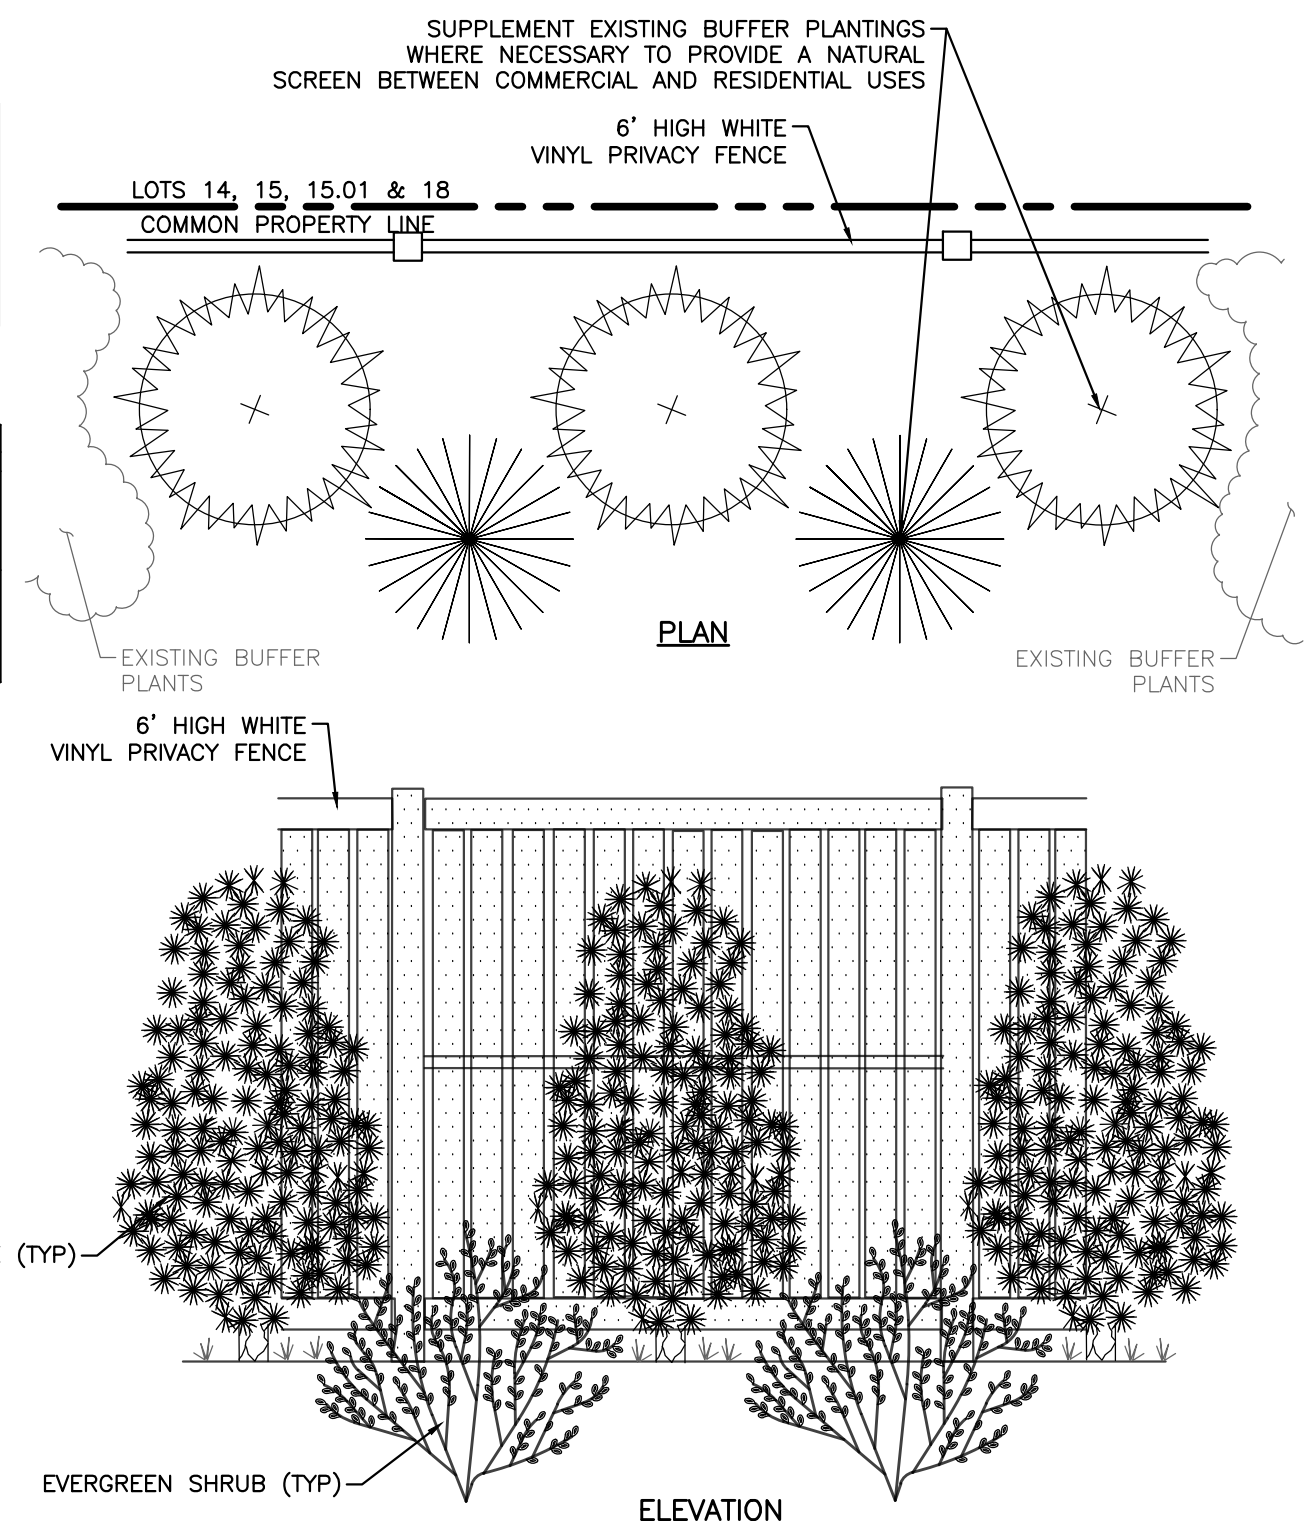

ABK4-11-BCK-54

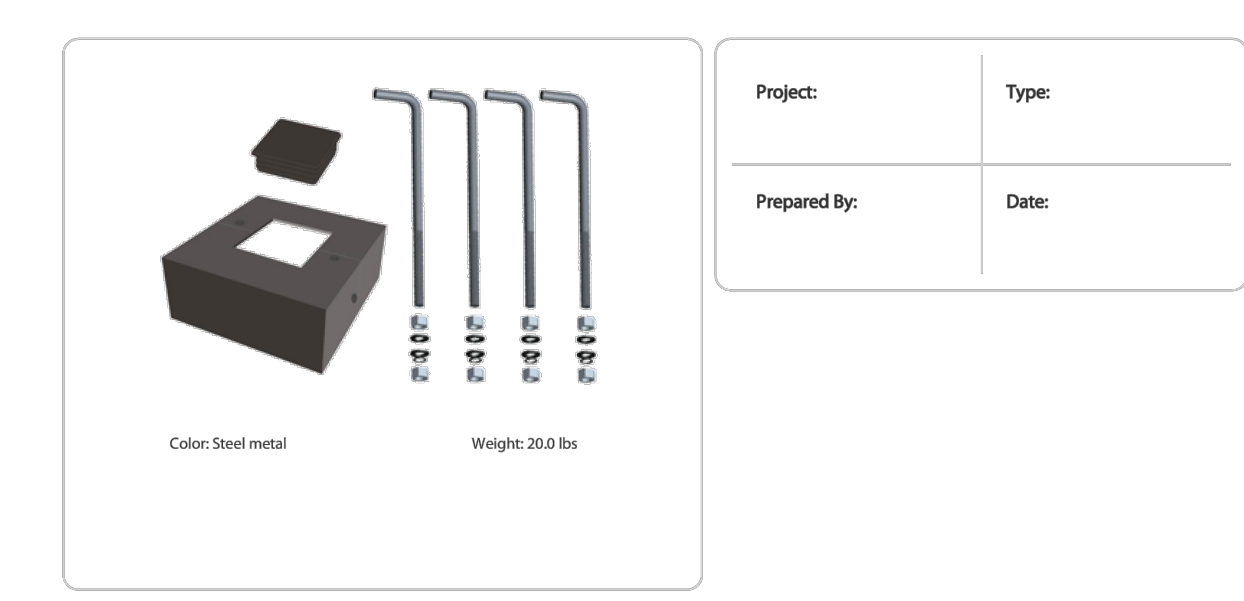

Technical Specifications

Performance: 1/2" square anchor bolt with 1/2" x 1/2" x 1/2" sheet for actual size. CHECK SCALE BEFORE USING. Templates shipped with anchor bolts and available online.

Construction: Anchor Bolt Template: WARNING: Template must be printed on 11" x 17" sheet for actual size. CHECK SCALE BEFORE USING. Templates shipped with anchor bolts and available online.

Finish: Formulated for high durability and long lasting color.

A17-4T150



Technical Specifications

Compliance: UL Listed: Suitable for wet locations.

ESNA LM-79 & LM-80 Testing: RAB LED luminaires and LED components have been tested by an independent laboratory in accordance with ESNA LM-79 and LM-80.

IP Rating: Progress protection rating of IP65 for dust and water.

DLI Listed: This product family is listed with the DesignLights Consortium (DLC). Individual SKUs within this family may carry either a DLC Standard or DLC Premium qualification. Please refer to the individual product specification sheet or the DLC Qualified Products List (QPL) in designlights.org to confirm the qualification status of a specific SKU prior to specification or purchase.

Electrical: Driver: 150W, Constant Current, Class 1, 120V-277V, 50/60Hz, 120V:1.21A, 208V:0.70A, 240V:0.63A, 277V:0.63A. 120W, Constant Current, Class 1, 120-277V, 50/60Hz, 120V:0.67A, 208V:0.56A, 240V:0.53A, 277V:0.64A. 100W, Constant Current, Class 1, 120-277V, 50/60Hz, 120V:0.61A, 208V:0.47A, 240V:0.42A, 277V:0.38A.

Dimming Driver: Driver includes dimming control wiring for 0-10V dimming systems. Requires separate 0-10V DC dimming circuit. Dimm down to 10%.

THD: 5.01% at 120V, 5.56% at 277V

Power Factor: 99.98% at 120V, 95.4% at 277V

Surge Protection: 4 kV

Performance: Lifespan: 100,000-Hour LED lifespan based on E53m-80 results and TM-21 calculations.

Optical: IES Classification: The Type IV distribution (also known as Forward Throw) is especially suited for mounting on the sides of buildings and walls, and for illuminating the perimeter of parking areas. It produces a semi-circular distribution with essentially the same candpower at lateral angles from 90° to 270°.

LED Characteristics: LED: Long-life, high-efficiency, surface-mount LEDs.



Color Uniformity: RAB's range of Correlated Color Temperature follows the guidelines of the American National Standard for Specifications for the Chromaticity of Solid State Lighting (SSL) Products, ANSI C78.377-2017.

Construction: Cold Weather Starting: The minimum starting temperature is -40°F (-40°C).

Maximum Ambient Temperature: Suitable for use in up to 104°F (40°C).

Ordering Matrix

Family	Distribution	Wattage/Lumens	Mounting	Color Temp	Finish	Driver	Options
A17	4T	150	Blank = 3000/4000/5000K CCT Adjustable	Blank = 3000/4000/5000K CCT Adjustable	Blank = Bronze	Blank = 120-277V, 0-10V Dimming Blank = 400V/0-10V Dimming	Blank = No Option ZPMS = 3-pin Photocell and Shipping Cap TPMS = 7-pin Photocell and Shipping Cap AMS = Microwave Motion Sensor ACBS = LightCloud Blue-w/IR Sensor ACBS/AMS = LightCloud Blue-w/IR Sensor w/MS Sensor

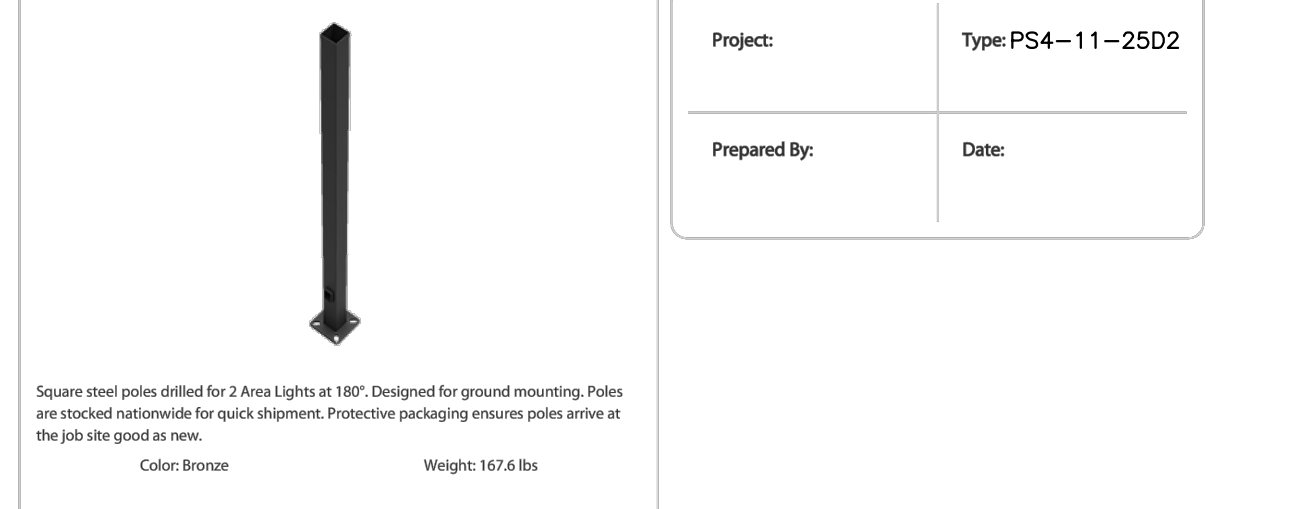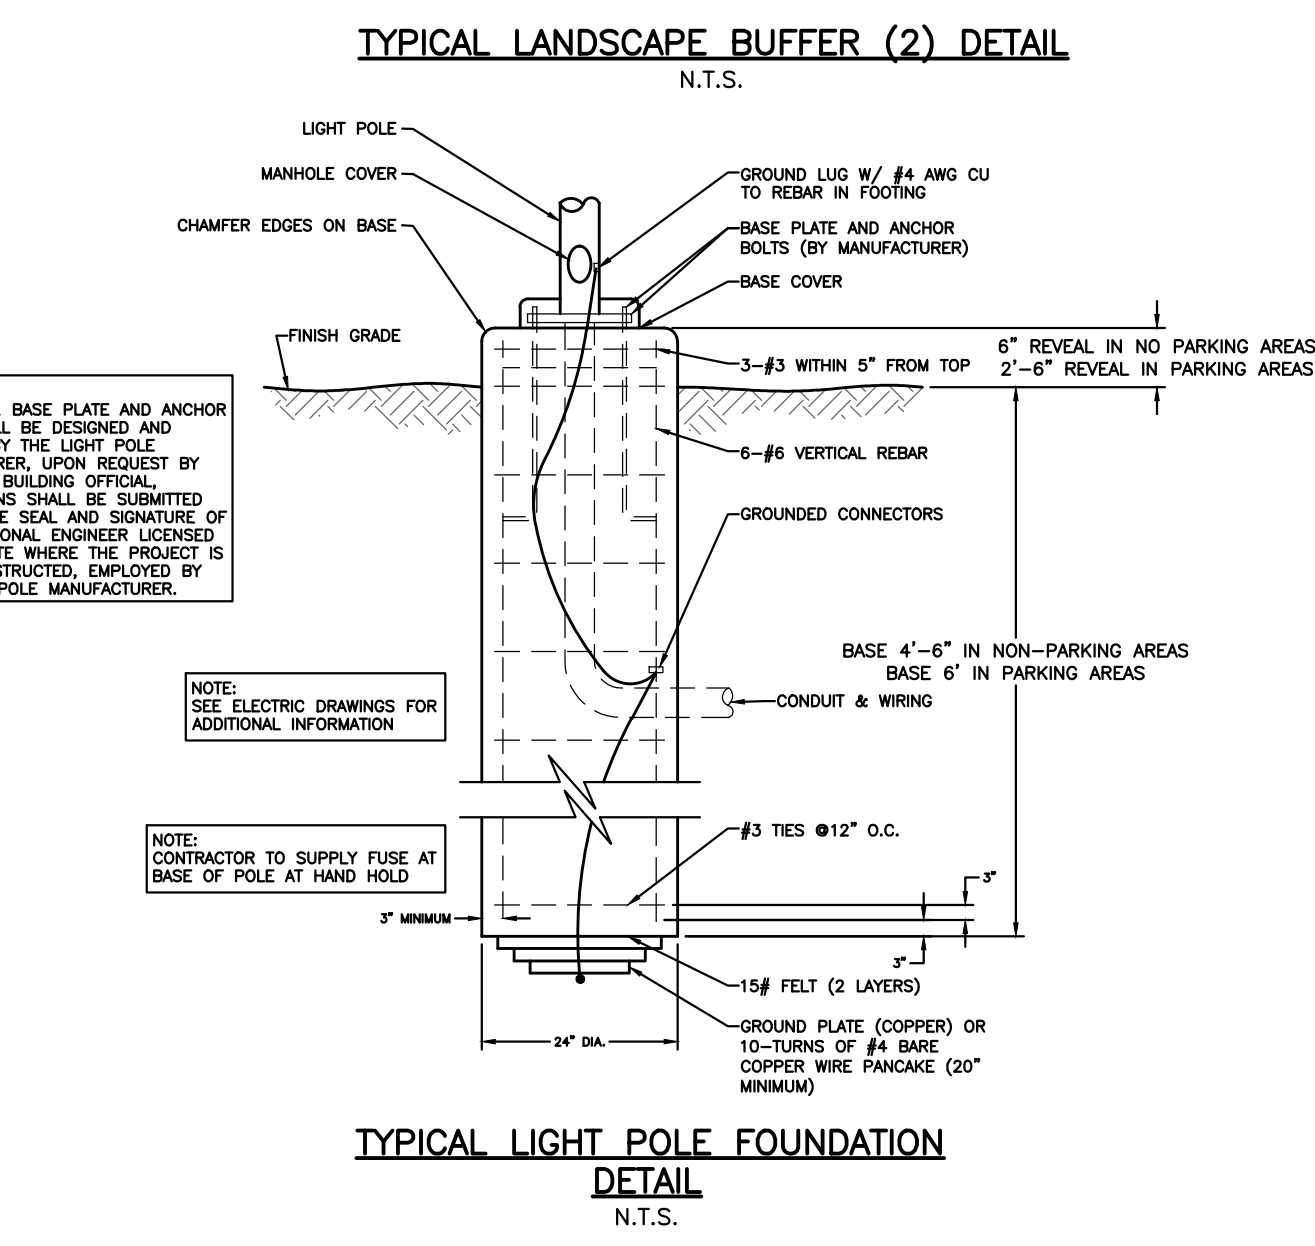

Technical Specifications

Compliance: CSA Listed: Suitable for wet locations.

Trade Agreements Act Compliance: This product is a product of Cambodia and a "designated country" end product that complies with the Trade Agreements Act.

Construction: Shaft: 46,000 p.s.i. minimum yield. Hand Hole: Reinforced with grounding lug and removable cover.

Base Plate: 36,000 p.s.i. minimum yield.

Shipping Protection: All poles are shipped in individual corrugated cartons to prevent finish damage.

Color: Bronze powder coating.

Height: 25 ft.

Weight: 168 lbs.

Geauge: 11

Wall Thickness: 1/8"

Shaft Size: 8 1/2"

Hand Hole Dimensions: 17 x 5"


Bolt Circle: 8 1/2"

Base Dimension: 8"

Anchor Bolt: Anchor bolts are sold separately. Order AB66.11, BCK54 for anchor bolt kits.

Anchor Bolt Templates: WARNING: Template must be printed on 11" x 17" sheet for actual size. CHECK SCALE BEFORE USING. Templates shipped with anchor bolts and available online.

NOTE: POLE TO BE CUT SO THAT MOUNTING HEIGHT FROM EXISTING GRADE IS MAX. 20'

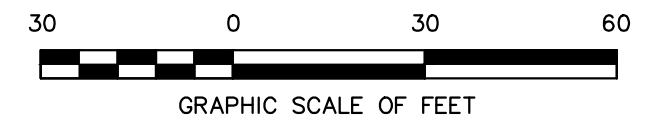

K2
Consulting Engineers, Inc.

Professional Civil Engineers
Certificate of Authorization
#24GA28187400

36 Tanner Street, Suite 100
Haddonfield, NJ 08033
Phone - 856.910.5205
Fax - 856.616.2441
www.K2CE.com

LANDSCAPE & LIGHTING PLAN
401 W 8TH STREET
BLOCK 111 - LOTS 1, 1.01 AND 1.02 - TAX MAP SHEET 22
BLOCK 110 - LOT 15.01, 16.01 AND 17.01 - TAX MAP SHEET 21
BOROUGH OF SHIP BOTTOM, OCEAN COUNTY, NEW JERSEY

DATE: 05/20/2026
DESIGN BY: WFR
DRAWN BY: WFR
SCALE: 1" = 30'
JOB NO.: PD26-021
SHEET: 5 OF 5